

Landscape Items



Outdoor bench seat



2.73


Proposed landscape area refer to landscape plan

Paving to public domain footpath to include: Dimensions: 600x300mm x 30mm

300x300mm x 30mm Finishes: London Grey Sandblasted Paver London Charcoal Sandblast Paver Refer to Insert Plan-Tree Pit Detail




Linear root barrier 600mm minimum depth required

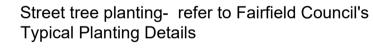


STREET TREES


Street trees shall be planted with minimum 100 Lt pot size, species selected from Fairfield City Council's Street Tree Planting Program Species List

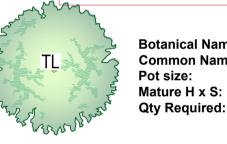

Botanical Name: Tristaniopsis laurina **Common Name:** Water Gum (Native) 100Lt **Mature H x S:** 8-10m x 5-8m

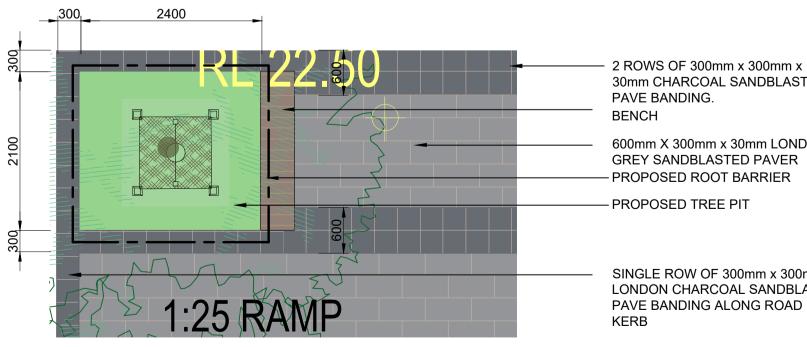

TREE PIT DETAIL-PLAN VIEW

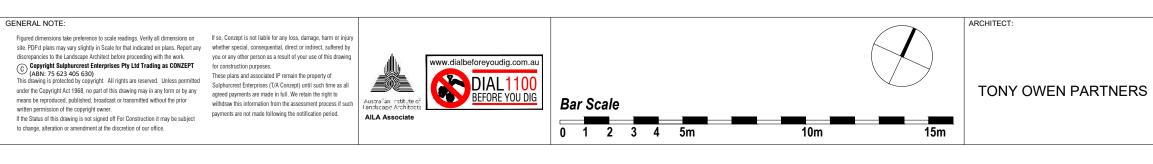




30mm CHARCOAL SANDBLAST PAVE BANDING.

600mm X 300mm x 30mm LONDON GREY SANDBLASTED PAVER - PROPOSED ROOT BARRIER - PROPOSED TREE PIT

SINGLE ROW OF 300mm x 300mm LONDON CHARCOAL SANDBLAST PAVE BANDING ALONG ROAD

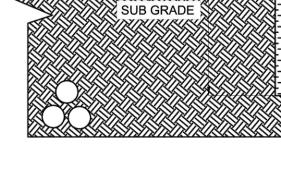

GEOTEXTILE MEMBRANE-

CONCRETE FOOTPATH


TREE PIT DETAIL PLANTING DETAILS 1/3

LANDSCAPE ARCHITEC Suit 101, 506 Miller Street, CAMMERAY NSW 2062 Phone: 9922 5312 Mob: 0413 861 351 www.conzept.net.au conzept enquiries@conzept.net.au

COUNCIL FAIRFIELD CITY CLIENT ABA PTY. LTD

REV DATE NOTATION/AMENDMENT A 21.10.2024 Preliminary plan prepared for review B 1.11.2024 Coordinated with client's comments C 12.11.2024 Coordinated with architectural updates & the arborist report D 16.12.2024 Coordinated with architectural comments

PROJECT: PROPOSED MIXED USE DEVELOPMENT 890 WOODVILLE ROAD VILLAWOOD

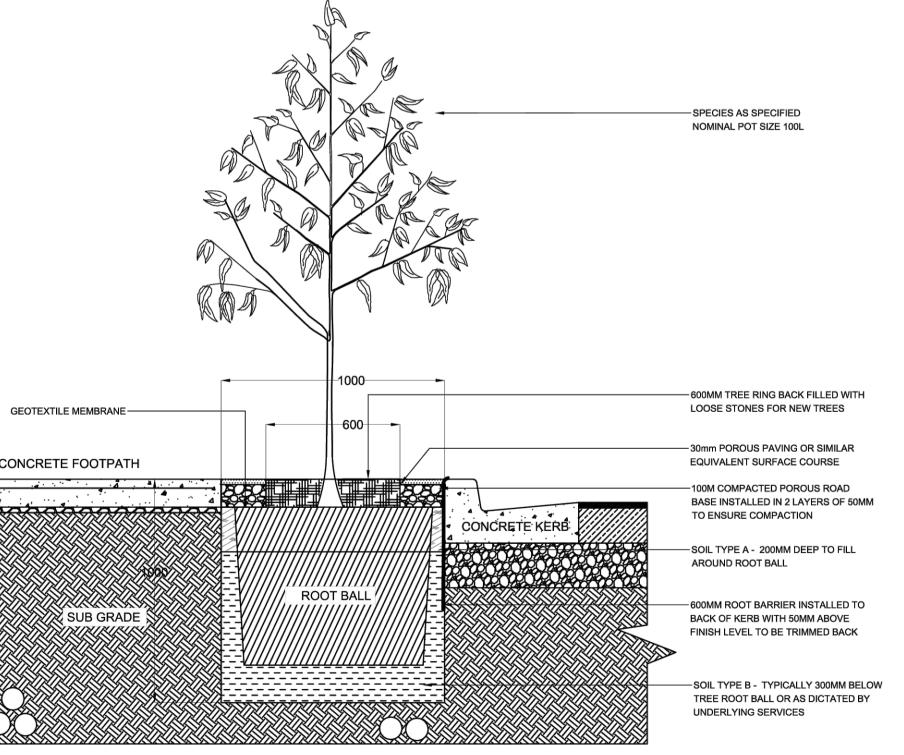

		PUBLIC DOMAIN PLAN		CATION
	Si and a second se		SCALE:	
			1:150@ A1	DEC 2024
			DRAWN:	CHECKED:
	LPDA 25- 75	LP02	L.Z/E.W	R.F

LEGEND & SCHEDULE

NOTES:

1. ALL FINAL PLANT QUANTITIES INDICATED ON PLANS SHALL BE CHECKED AND VERIFIED BY SUCCESSFUL LANDSCAPE CONTRACTOR.


2. ANY PLANT SUBSTITUTES REQUIRED DUE TO UNAVAILABILITY SHALL BE RECOMMENDED BY THE LANDSCAPE CONTRACTOR TO BEST MATCH SUBSTITUTED PLANTS AND APPROVED PRIOR TO PURCHASING BY THE LANDSCAPE ARCHITECT. 3. WORKS CERTIFIED FOR FINAL OCCUPANCY CERTIFICATE ARE TO MATCH APPROVED LANDSCAPE PLANS.

4. LANDSCAPE CONTRACTOR SHALL LOCATE AND AVOID SITE STORM WATER & DRAINAGE SERVICES. LOCATE TREES A MINIMUM 1.25M FROM PITS 5. ALL PLANTING AROUND EXISTING TREES SHALL BE ADJUSTED TO AVOID

DAMAGE AND CLASHING WITH SURFACE ROOTS 6. THE NATURE STRIP (STREET FRONTAGE) FOR THE SITE IS PUBLIC LAND, AND ONLY AUTHORIZED WORKS MAY OCCUR HERE. EXISTING CONDITIONS SUCH AS STREET TREES, COUNCIL PLANTING ETC SHALL BE RETAINED AND PROTECTED DURING CONSTRUCTION, UNLESS SPECIFIC APPROVAL HAS BEEN GRANTED FOR NEW WORK IN THIS AREA.

7. ALL TREES TO BE SOURCED IN ACCORDANCE WITH TESTS AND MEASUREMENTS CONTAINED WITHIN AS 2303-2015 - TREE STOCK FOR LANDSCAPE USE

CONTAINED WITHIN AS 2303-2015 - TREE STOCK FOR LANDSCAPE USE STREET TREE						
SIREEI						
TL AND	Botanical Name: Common Name: Pot size: Mature H x S:	<i>Tristaniopsis laurina</i> Water Gum (Native) 100Lt 8-10m x 5-8m				
TREES	Qty Required:	3				
AS	Botanical Name: Common Name: Pot size:	Lillypilly (Native) 75Lt				
	Mature H x S: Qty Required:	12 x 7m 1				
WF WF	Botanical Name: Common Name: Pot size: Mature H x S: Qty Required:	<i>Waterhousia floribunda Weeping Lilly Pilly</i> (Native) 75Lt 10m x 6m 3				
	Botanical Name: Common Name: Pot size: Mature H x S: Qty Required:	<i>Elaeocarpus reticulatus</i> Blueberry Ash (Native) 75Lt 8-10m x 6-7m 5				
NS NS	Botanical Name: Common Name: Pot size: Mature H x S: Qty Required:	<i>Nyssa sylvatica</i> Black Tulepo (Exotic) 75Lt 12m x 6m 1				
	Common Name: Pot size: Mature H x S:	<i>Syzygium 'Cascade'</i> Cascade Lilly Pilly (Native) 200mm 2.5m x 1.8m				
	Qty Required: Botanical Name:	40 Westringia fruticosa				
WF	Common Name: Pot size: Mature H x S: Qty Required:	Native Rosemary (Native) 200mm 1.3m x 1.1m 7				
BSB	Botanical Name: Common Name: Pot size: Mature H x S: Qty Required:	<i>Banksia spinulosa 'Birthday Candles'</i> Banksia Birthday Candles (Native) 200mm 0.6m x 0.9m 14				
STT	Botanical Name: Common Name: Pot size: Mature H x S: Qty Required:	<i>Syzygium 'Tiny Trev'</i> Dwarf Lilly Pilly (Native) 200mm 1m x 1m tbc				
FEA	TURE & FE					
са Суа	Botanical Name: Common Name: Pot size: Mature H x S: Qty Required:	<i>Cyathea australis</i> Rough Tree Fern (Native) 45L 2.5-5m x 3m 9				
DA 🌞	Botanical Name: Common Name: Pot size: Mature H x S: Qty Required:	<i>Doodia aspera</i> Prickly Rasp Fern (Native) 150mm 0.4m x 0.5m 13				
PX 🏘		<i>Philodendron 'Xanadu'</i> Xanadu Plant (Exotic) 200mm 0.7m x 0.7m 33				
GROUN		& GRASSES				
LLT	Botanical Name: Common Name: Pot size: Mature H x S: Qty Required:	Lomandra longifollia 'Tanika' Lomandra Tanika (Native) 140mm 0.8m x 0.8m 3/m2 (43m2 total)				
тт	Botanical Name: Common Name: Pot size: Mature H x S: Qty Required:	<i>Trachelospermum 'Tricolour'</i> Tricolour Jasmine (Exotic) 140mm 0.2m x spreading 5/m2 (23m2 total)				
Vh	Botanical Name: Common Name: Pot size: Mature H x S: Qty Required:	Viola hederacea Native Violet(Native) 140mm 0.2m x spreading 7/m2 (35m2 total)				

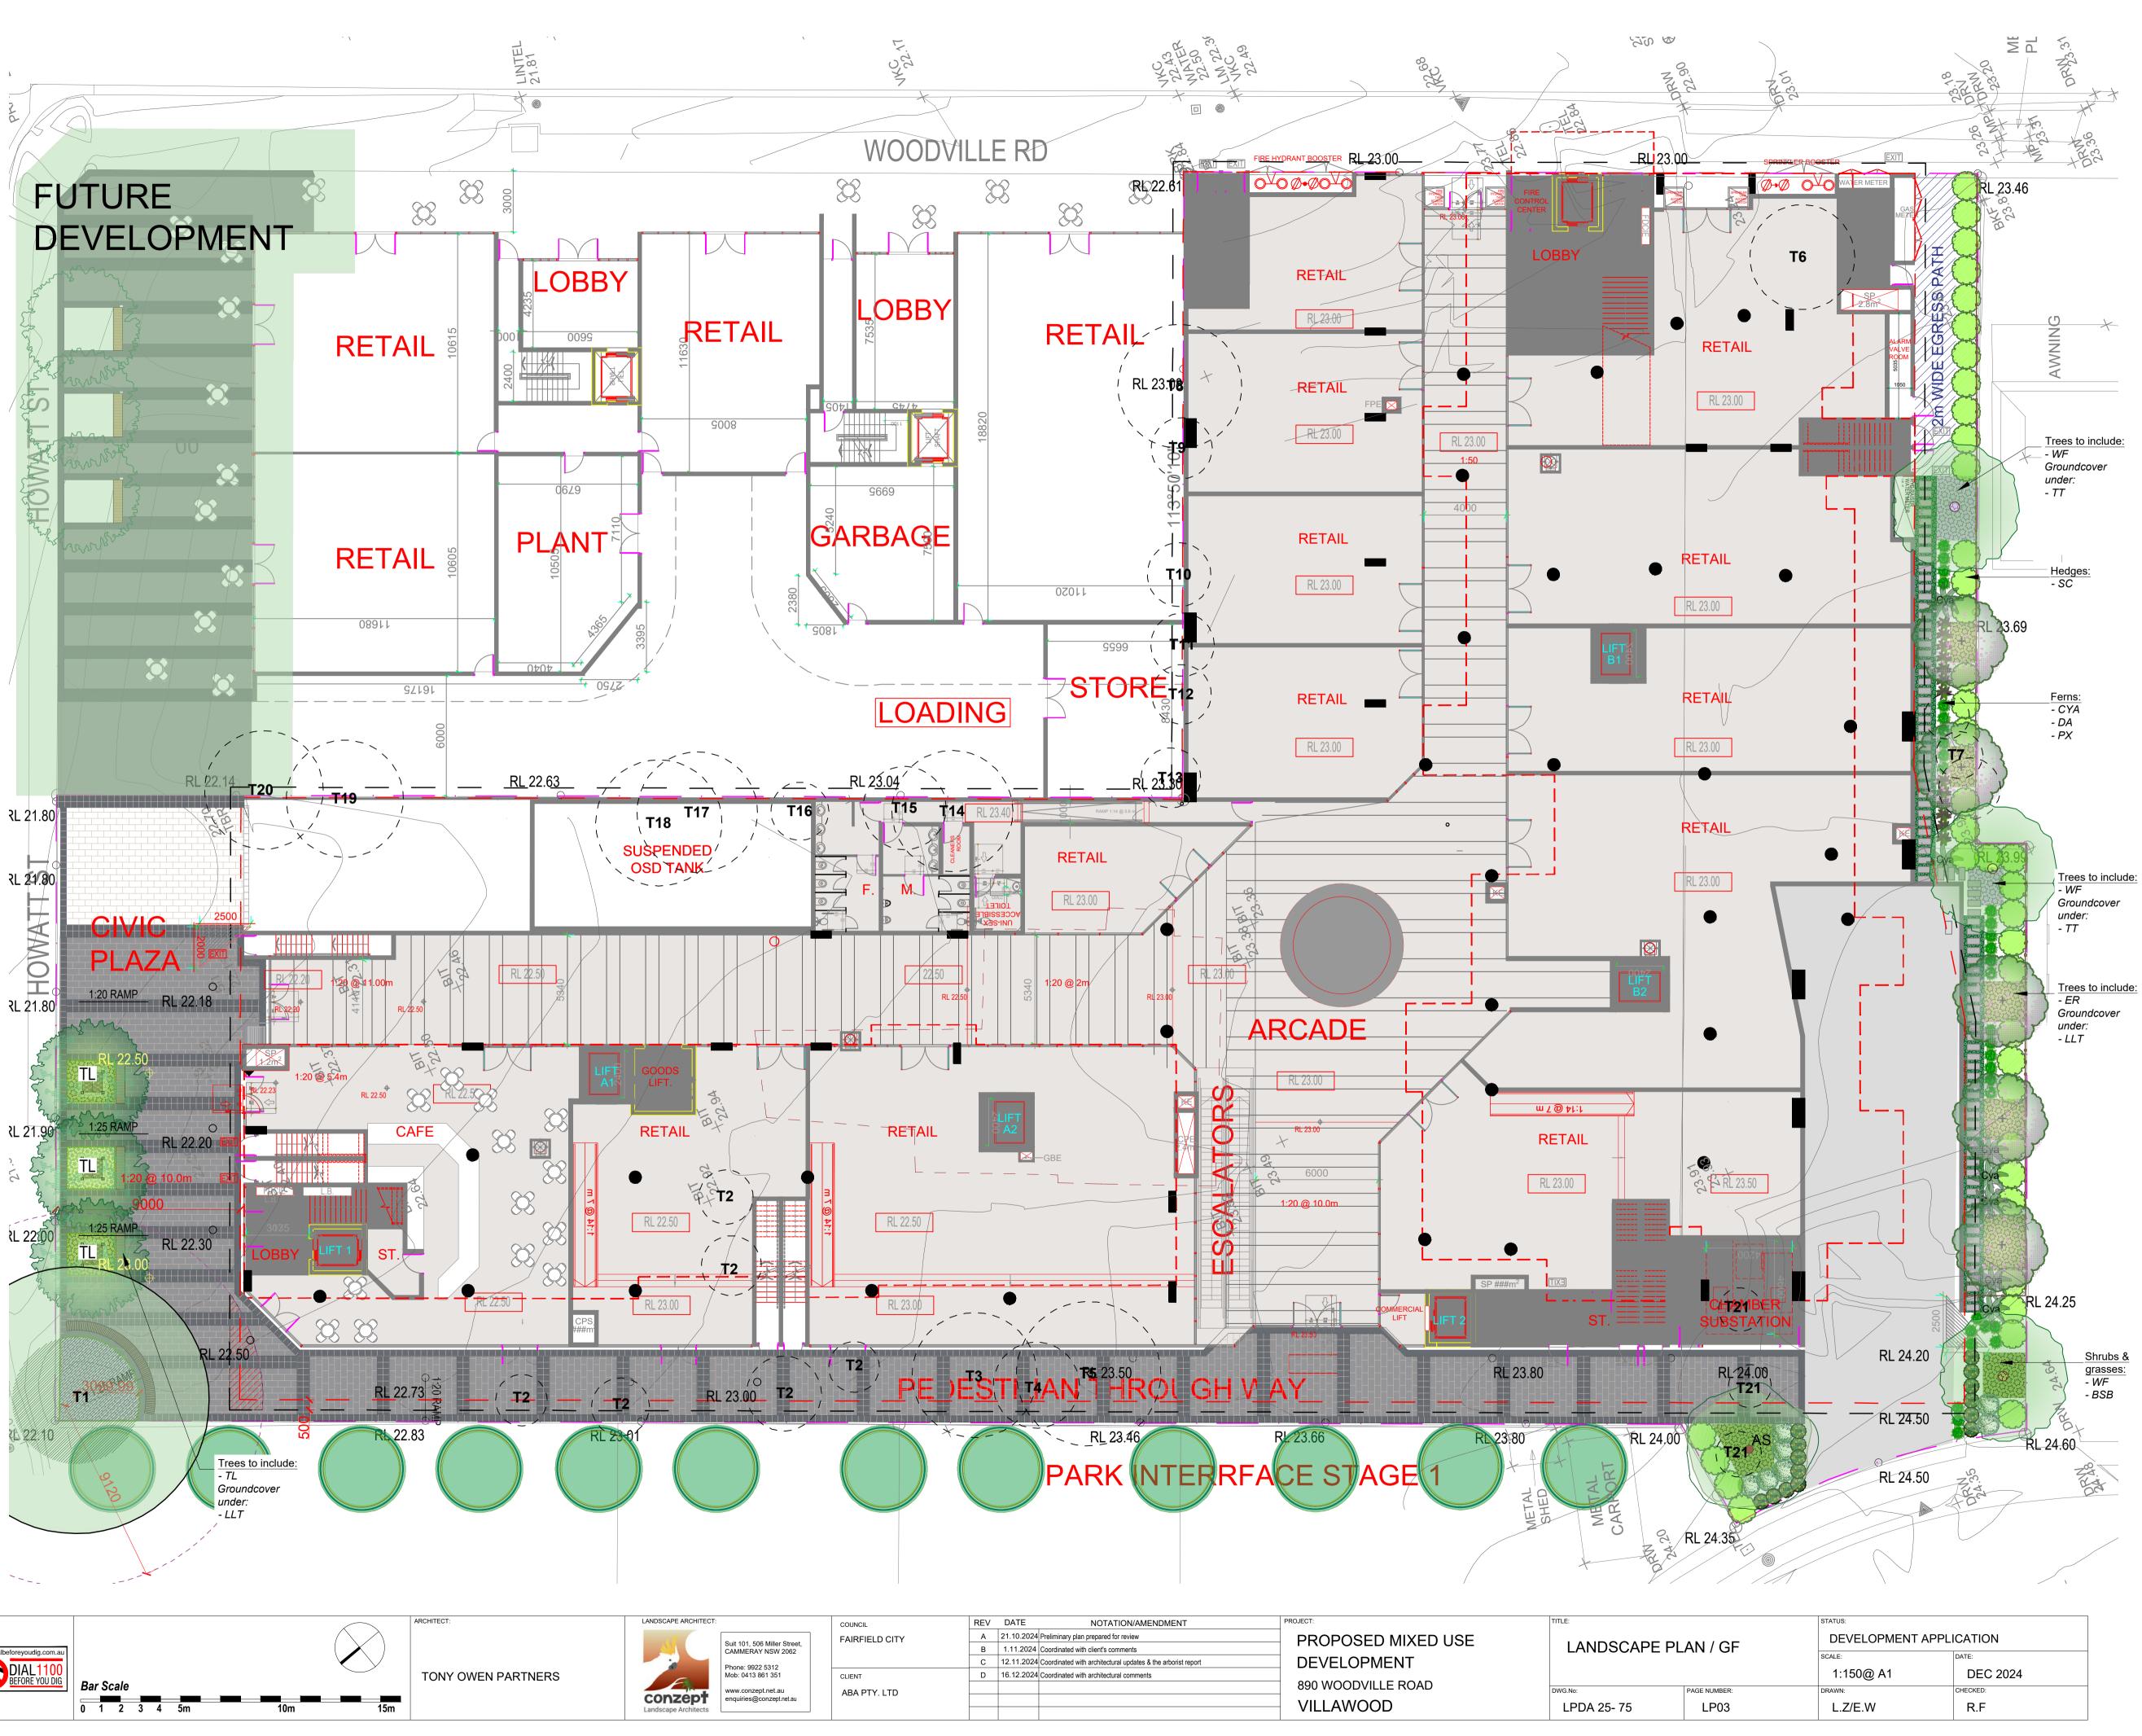


Figured dimensions take preference to scale readings. Verify all dimensions on site. PDF'd plans may vary slightly in Scale for that indicated on plans. Report any whether special, consequential, direct or indirect, suffered by site: For u pais may vary signing in calculate to the minimized on pais, heport a discrepancies to the Landszeger Architect before proceeding with the work. (C) Copyright Sulphurcrest Enterprises Pty Ltd Trading as CONZEPT This drawing is protected by copyright. All rights are reserved. Unless permitted under the Copyright Act 1968, no part of this drawing may in any form or by any means be reproduced, published, broadcast or transmitted without the prior written permission of the copyright owner. payments are not made following the notification period. If the Status of this drawing is not signed off For Construction it may be subject

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			DEVELOPMENT APPLICATION	
		SCALE:	DATE:	
	DWG.No: PAGE NUMBER: LPDA 25- 75 LP03		1:150@ A1	DEC 2024
DV			DRAWN:	CHECKED:
			L.Z/E.W	R.F

LEGEND & SCHEDULE

NOTES

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SUBSTITUTED PLANTS AND APPROVED PRIOR TO PURCHASING BY THE LANDSCAPE ARCHITECT. 3. WORKS CERTIFIED FOR FINAL OCCUPANCY CERTIFICATE ARE TO
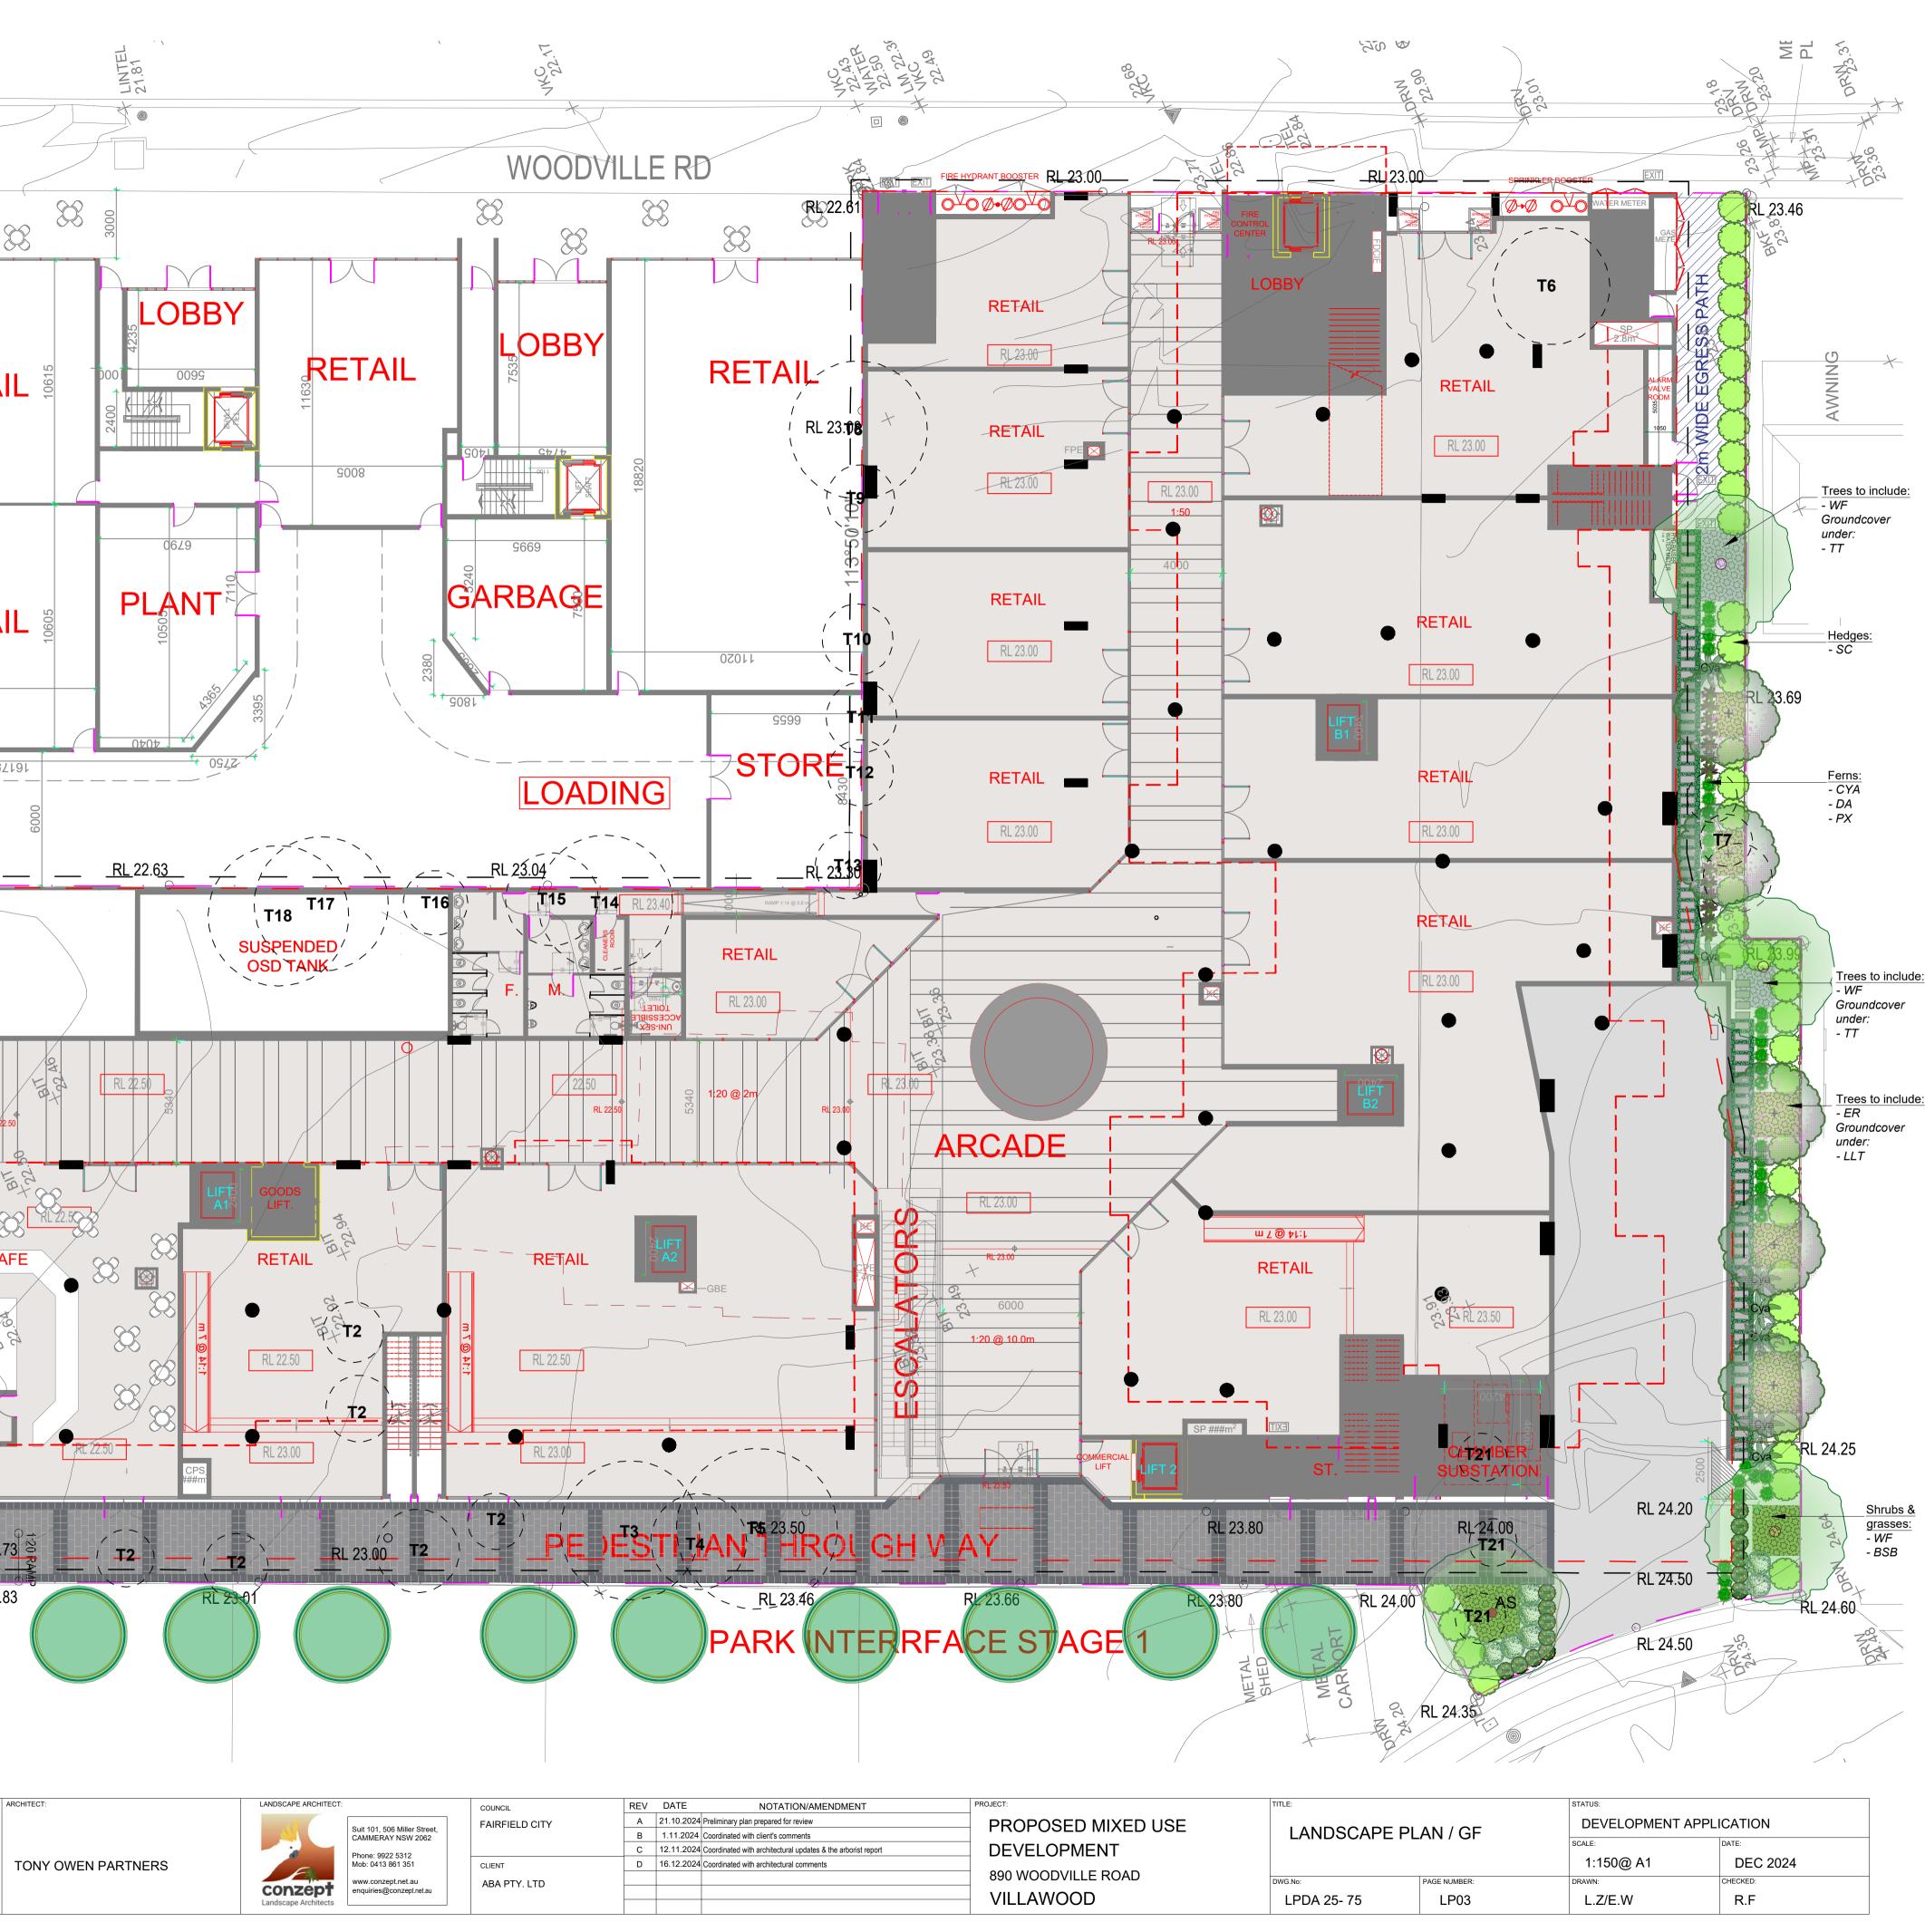
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MEASUREMENTS CONTAINED WITHIN AS 2303-2015 - TREE STOCK FOR LANDSCAPE USE

TDEES

ASM

BSB

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STT

SC

SR

AA

RE

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AIR

DA

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GENERAL NOTE:

BSB

	Botanical Name: Common Name: Pot size: Mature H x S: Qty Required:	<i>Waterhousia floribunda Weeping Lilly Pilly</i> (Native) 75Lt 10m x 6m 2
BS	Botanical Name: Common Name: Pot size: Mature H x S: Qty Required:	<i>Banksia serrata</i> Old Man Banksia (Native) 75Lt 5m x 3m 2
LI De	Botanical Name: Common Name: Pot size: Mature H x S: Qty Required:	<i>Lagerstroemia indica</i> Crepe myrtle (Exotic) 75Lt 8m x 5m 2
APA	Botanical Name: Common Name: Pot size: Mature H x S: Qty Required:	<i>Acer palmatum 'Ariadne'</i> Japanese maple (Exotic) 75Lt 3m x 4m 4

SHRUBS & SCF

Pot size:

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& SCREEN	PLANTING
Botanical Name:	<i>Acmena smithii 'Minor'</i>
Common Name:	Minor Lilly Pilly (Native)
Pot size:	200mm
Mature H x S:	2-3m x 2m
Qty Required:	30
Botanical Name: Candles' Common Name: Pot size: Mature H x S: Qty Required:	Banksia spinulosa 'Birthday Banksia Birthday Candles (Native) 200mm 0.6m x 0.9m 13
Botanical Name:	<i>Metrosideros</i> 'Tahiti'
Common Name:	NZ Christmas Bush (Exotic)
Pot size:	200mm
Mature H x S:	1m x 1m
Qty Required:	26

Botanical Name: Syzygium 'Tiny Trev' Common Name: Dwarf Lilly Pilly (Native) 200mm Mature H x S: 1m x 1m Qty Required: 15

Botanical Name: Syzygium 'Cascade' **Common Name:** Cascade Lilly Pilly (Native) 200mm Mature H x S: 2.5m x 1.8m Qty Required: 68

FEATURE & FERNS

Botanical Name: Strelitzia reginae **Common Name:** Bird of Paradise (Exotic) 300mm Mature H x S: 1-2m x 1.5m Qty Required: 1

Botanical Name: Asplenium australasicum **Common Name:** Birds Nest Fern (Native) 200mm Mature H x S: 1m x 1.4m Qty Required: 11

Botanical Name: Rhaphis excelsa **Common Name:** Rhaphis Palm (Exotic) 200mm Mature H x S: 3m x 1.5m

200mm

Botanical Name: Alcantarea imperialis 'Rubra' **Common Name:** Ruby Imperial Bromeliad (Exotic) Pot size: 300mm Mature H x S: 0.8m x 0.9m

Botanical Name: Doodia aspera **Common Name:** Prickly Rasp Fern (Native) 150mm Mature H x S: 0.4m x 0.5m Qty Required: 14

Botanical Name: *Philodendron 'Xanadu'* **Common Name:** Xanadu Plant (Exotic) 200mm Mature H x S: 0.7m x 0.7m Qty Required: 27

agreed payments are made in full. We retain the right to

payments are not made following the notification period.

withdraw this information from the assessment process if such andscape Architects

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AILA Associate

Communal Open Space Rooftop Terraces GENERAL NOTE

BCA & Australian Standards (AS):

Building codes and standards are established on a federal level by the nationally recognised Building Code of Australia (BCA), & these apply to all phases of construction, including balustrade design and specification. Specifically, BCA 2012 Parts 3.9.1 (stairs) and 3.9.2 (balustrades) and Australian Standard 1170.1 cover regulations for balustrades on stairways, balconies, rooftop terraces and other surfaces between levels.

BCA Balustrade Regulations and Standards

A balustrade is defined as a rail and its balusters (posts or other supporting members). BCA regulations state that a balustrade must:

- Be at least 1 metre high as measured from the finished floor;
- Have openings between risers or posts no greater than 125mm; and
- Be able to withstand loads and impacts as determined by AS 1170.1

The height regulation of 1 metre ensures the balustrade is high enough to provide prevention against falling over the balustrade. The openings between risers or posts cannot be greater than 125mm to prevent children from falling between them. Load and impact regulations are designed to ensure balustrades can resist impact or will not collapse when pressure is applied to them from any direction.

Balustrade Safety & Planters

BCA regulations state that the balustrade must be 1 metre or more, higher than the finished floor. On roof-top terraces, planters & furniture are often incorporated in the landscape design. It's important for compliance and safety that these elements do not undermine the safety of Communal Open Space (COS) terraces and rooftops, and the compliance with the BCA and AS's are maintained.

Items to consider are:

- Where planters form the safety balustrade, their internal face must be 1m non-climbable
- Outdoor furniture such as tables, BBQs, and seating shall be fixed and located a minimum 1m away from balustrades
- Where furniture is proposed to be fixed or adjacent to COS terrace planters which form the balustrade, then a compliant handrail will be required to be fixed to the external edge of the planter

A concern for COS areas on rooftops or terrace areas is that the strata will add loose furniture which ultimately could undermine the safety of the installed balustrades. In this case, it shall be the strata bodies responsibility to manage the safety of these areas.

Ultimately, the compliance and safety of the COS areas shall be the responsibility of the builder, and carefully inspected and certified at the Occupation Certificate (OC) stage of the development

Maintenance of COS area

Communal Open Space terrace and rooftop areas are exposed to extremes (wind, sun, and extreme weather) so maintenance is important. The following item should be included or considered:

- All planters shall be structurally water-proofed, with this work certified and periodically inspected. Trades should be closely monitored so they do not subsequently damage completed waterproofing
- All planters shall be irrigated with an automated system set on an approved watering pattern. Moisture gauges should be installed in some planters to minimize overwatering
- **Tree Anchors** shall be installed in high wind areas to larger plants, such as palms & small trees
- Compliance for balustrades and handrails should be monitored regularly

without externa	al balustrades, ar	oftop areas and planters achoring points for tying off nance workers are essential		
GROUN	DCOVERS Botanical Name: Common Name: Pot size: Mature H x S: Qty Required:	& GRASSES Dichondra argentea 'Silver Falls' Silver Falls Dichondra (Exotic) 140mm 0.15m x spreading 9/m2 (21m2 total)		
тт	Botanical Name: Common Name: Pot size: Mature H x S: Qty Required:	<i>Trachelospermum 'Tricolour'</i> Tricolour Jasmine (Exotic) 140mm 0.2m x spreading 5/m2 (4m2 total)		CAP Picke - refe Reta
CAR	Botanical Name: Common Name: Pot size: Mature H x S: Qty Required:	Carpobrotus 'Aussie Rambler' Aussie Rambler Pigface (Native) 140mm 0.25m x spreading 7/m2 (11m2 total)		to ty Safe Turf
LLT	Botanical Name: Common Name: Pot size: Mature H x S: Qty Required:	<i>Lomandra longifollia 'Tanika'</i> Lomandra Tanika (Native) 200mm 0.8m x 0.8m 3/m2 (10m2 total)		Artif Rub
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NDS	CAPE ITEM
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DD-	Safety balustra
	Turf area - refe
↓ ↓ ↓ ↓ ↓	Artificial turf ar

bberised soft fall




0 1 2 3 4

Qty Required: 17 Botanical Name: Zamia furfuracea **Common Name:** Cardboard Palm (Exotic)

Mature H x S: 1m x 1.25m Qty Required: 44

Qty Required: 3

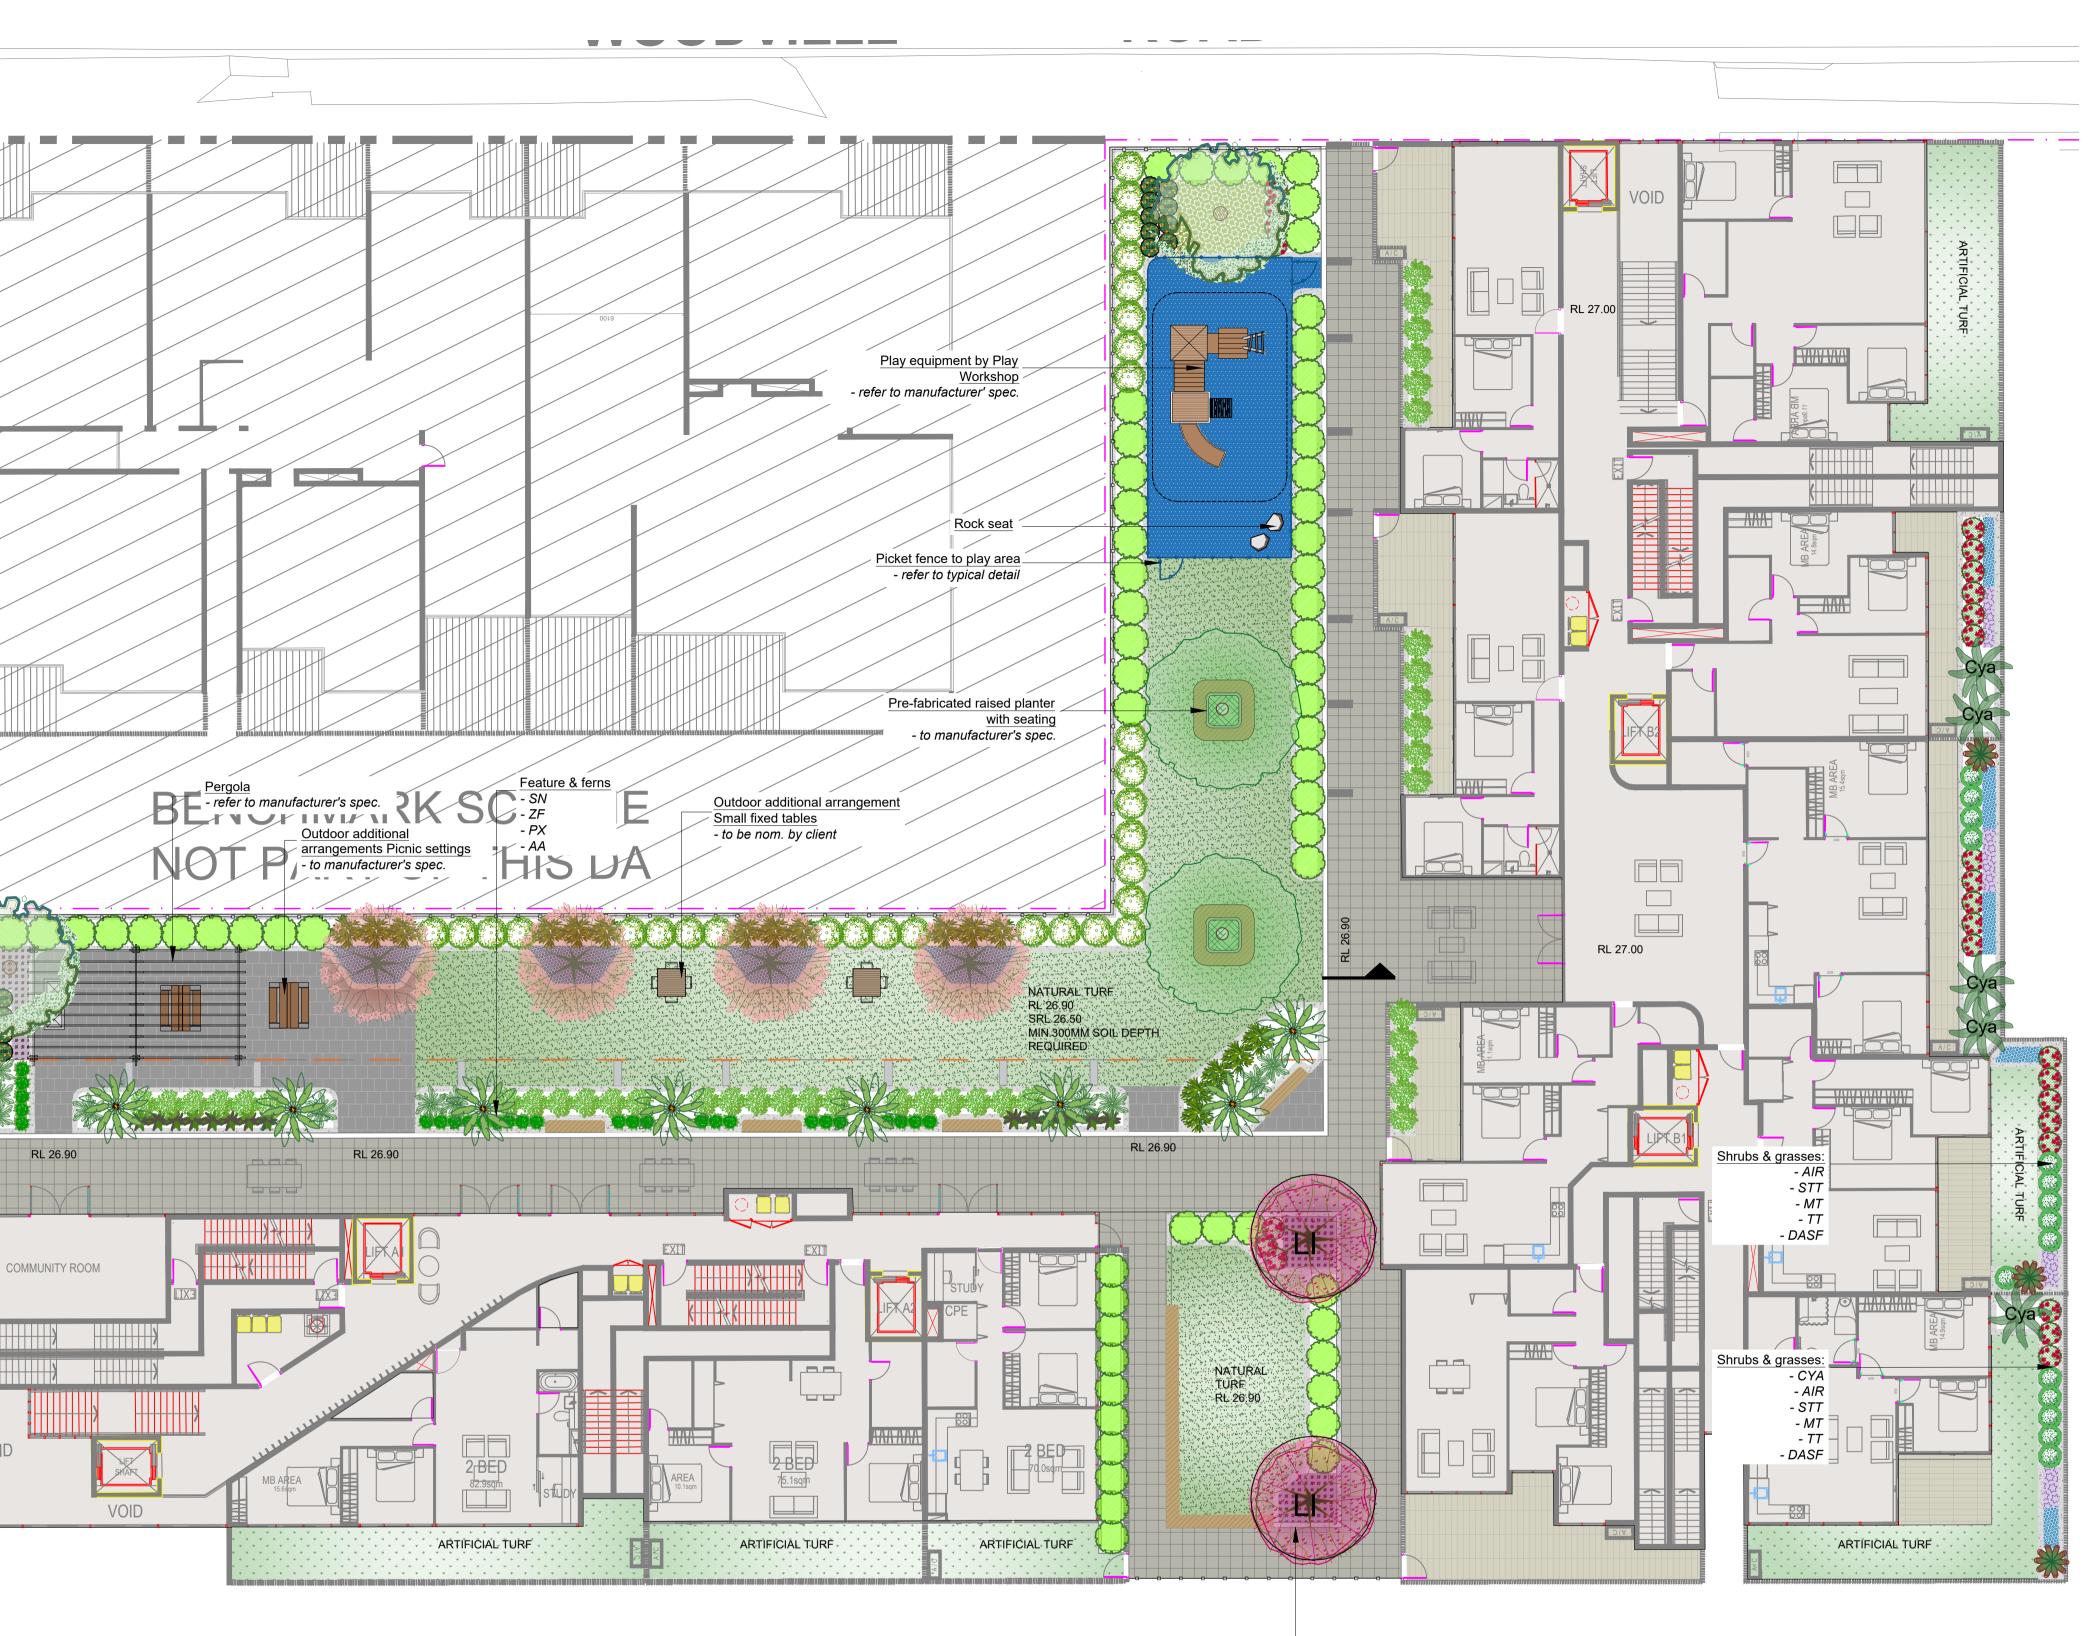

o children's play area al detail

sed planter wall - refer

ide

fer detail

rea - refer detail

LANDSCAPE ARCHITECT

conzept



Suit 101, 506 Miller Street,

AMMERAY NSW 2062

Phone: 9922 5312

Mob: 0413 861 351

www.conzept.net.au

enquiries@conzept.net.au

Play equipment by Play Workshop - refer to manufacturer's spec.

Pergola- refer to manufacturer's spec.



Pre-fabricated raised garden planter with

Outdoor additional arrangements-

BBQ to be nom. by client

Outdoor additional arrangements-

Picnic settings to be nom. by client



- refer to manufacturer's spec.

COUNCIL	REV	DATE	NOTATION/AMENDMENT
FAIRFIELD CITY	Α	21.10.2024	Preliminary plan prepared for review
	В	1.11.2024	Coordinated with client's comments
	С	12.11.2024	Coordinated with architectural updates & the arborist report
CLIENT	D	16.12.2024	Coordinated with architectural comments
ABA PTY. LTD			
		•	

PROPOSED MIXED USE DEVELOPMENT 890 WOODVILLE ROAD VILLAWOOD

Trees to include: - LI Groundcover under: - CAR



FOR ADVANCED TREE PLANTING IN HIGH WIND AND ROOFTOP LOCATIONS, IT IS RECOMMENDED THAT AN APPROVED ROOT BALL ANCHORING SYSTEM EQUAL TO 'PLATIPUS OR ZINCO ANCHORS' SHALL BE USED. INSTALL AS PER THE MANUFACTURERS

SPECIFICATION

LANDSCAPE PLAN / L1		DEVELOPMENT APPLICATION		
	SCALE:	DATE:		
	DWG.No: PAGE NUMBER:		1:150@ A1	DEC 2024
			DRAWN:	CHECKED:
	LPDA 25- 75	LP04	L.Z/E.W	R.F

LEGEND & SCHEDULE

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3. WORKS CERTIFIED FOR FINAL OCCUPANCY CERTIFICATE ARE TO

MATCH APPROVED LANDSCAPE PLANS. 4. LANDSCAPE CONTRACTOR SHALL LOCATE AND AVOID SITE STORM

WATER & DRAINAGE SERVICES. LOCATE TREES A MINIMUM 1.25M FROM PITS


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7. ALL TREES TO BE SOURCED IN ACCORDANCE WITH TESTS AND MEASUREMENTS CONTAINED WITHIN AS 2303-2015 - TREE STOCK FOR

TREES

LANDSCAPE USE



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Botanical Name: Banksia serrata **Common Name:** Old Man Banksia (Native) 45Lt Mature H x S: 5m x 3m Qty Required: 1 **Botanical Name:** Acer palmatum 'Ariadne' **Common Name:** Japanese maple (Exotic) 45Lt Mature H x S: 3m x 4m

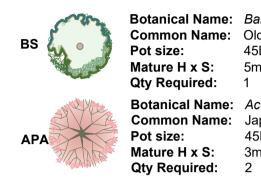SHRUBS & SCREEN PLANTING




Botanical Name: Strelitzia reginae

Pot size:

Pot size:

Pot size:

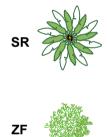

Qty Required: 1 **Botanical Name:** Zamia furfuracea **Common Name:** Cardboard Palm (Exotic) 200mm **Mature H x S:** 1m x 1.25m Qty Required: 11

Common Name: Bird of Paradise (Exotic)

Mature H x S: 1-2m x 1m

300mm

Botanical Name: Russelia equisetiformis Common Name: Firecracker (Exotic) 200mm Mature H x S: 1m x 1.2m Qty Required: 16

Botanical Name: Philodendron 'Xanadu' **Common Name:** Xanadu Plant (Exotic) Pot size: 200mm Mature H x S: 0.7m x 0.7m Qty Required: 32

GROUNDCOVERS & GRASSES Botanical Name: Dichondra argentea 'Silver Falls'

DASF

RF

PX 🎆


Common Name: Silver Falls Dichondra (Exotic) 140mm Pot size: Mature H x S: 0.15m x spreading Qty Required: 9/m2 11m2 total) **Botanical Name:** Carpobrotus 'Aussie Rambler'

CAR

Common Name: Aussie Rambler Pigface (Native) 140mm Mature H x S: 0.25m x spreading Qty Required: 7/m2 (10m2 total)

LANDSCAPE ITEMS

Pot size:

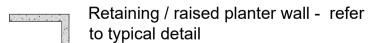

Integrated seat bench on planter

---------- Safety balustrade



GENERAL NOTE:

Turf area - refer detail

PLANT IMAGES



Banksia serrata



Acer palmatum 'Ariadne'



Metrosideros 'Tahiti'



Westringia 'Aussie Box'



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Rhaphiolepis indica



Strelitzia reginae






Russelia equisetiformis









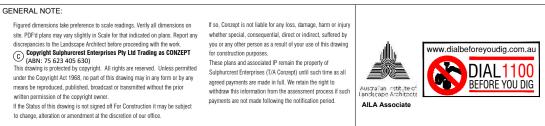



Bar Scale 0 2

4



10m

6


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ARCHITEC^{*}





N PARTNERS	Suit 101, 506 Miller Street, CAMMERAY NSW 2062 Phone: 9922 5312 Mob: 0413 861 351	COUNCIL FAIRFIELD CITY CLIENT ABA PTY. LTD	REV DATE NOTATION/AMENDMENT A 21.10.2024 Preliminary plan prepared for review B 1.11.2024 Coordinated with client's comments C 12.11.2024 Coordinated with architectural updates & the arborist report D 16.12.2024 Coordinated with architectural comments	PROJECT: PROPOSED DEVELOPM 890 WOODVILL	MIXED USE ENT
				TERRACE BELOW	2 BED 83.2sqm
			Trees with raised garden planter: - 1 APA Groundcover under: - DASF		
Philodendron 'Xanadu'			3 MT	RL 55	5.25 Mint 3
Carpobrotus 'Aussie Rambler'			Trees with raised garden planter: - 1 APA Groundcover under: - DASF 4 MT	RL 5	
		· · · · · · · · · · · · · · · · · · ·	Outdoor Bench (optional) - to be nom. by client Safety balustrade where is necessary to NCC standards		
Dichondra argentea 'Silver Fall	lis'				
<image/>				BED+S BED+S	STUDY

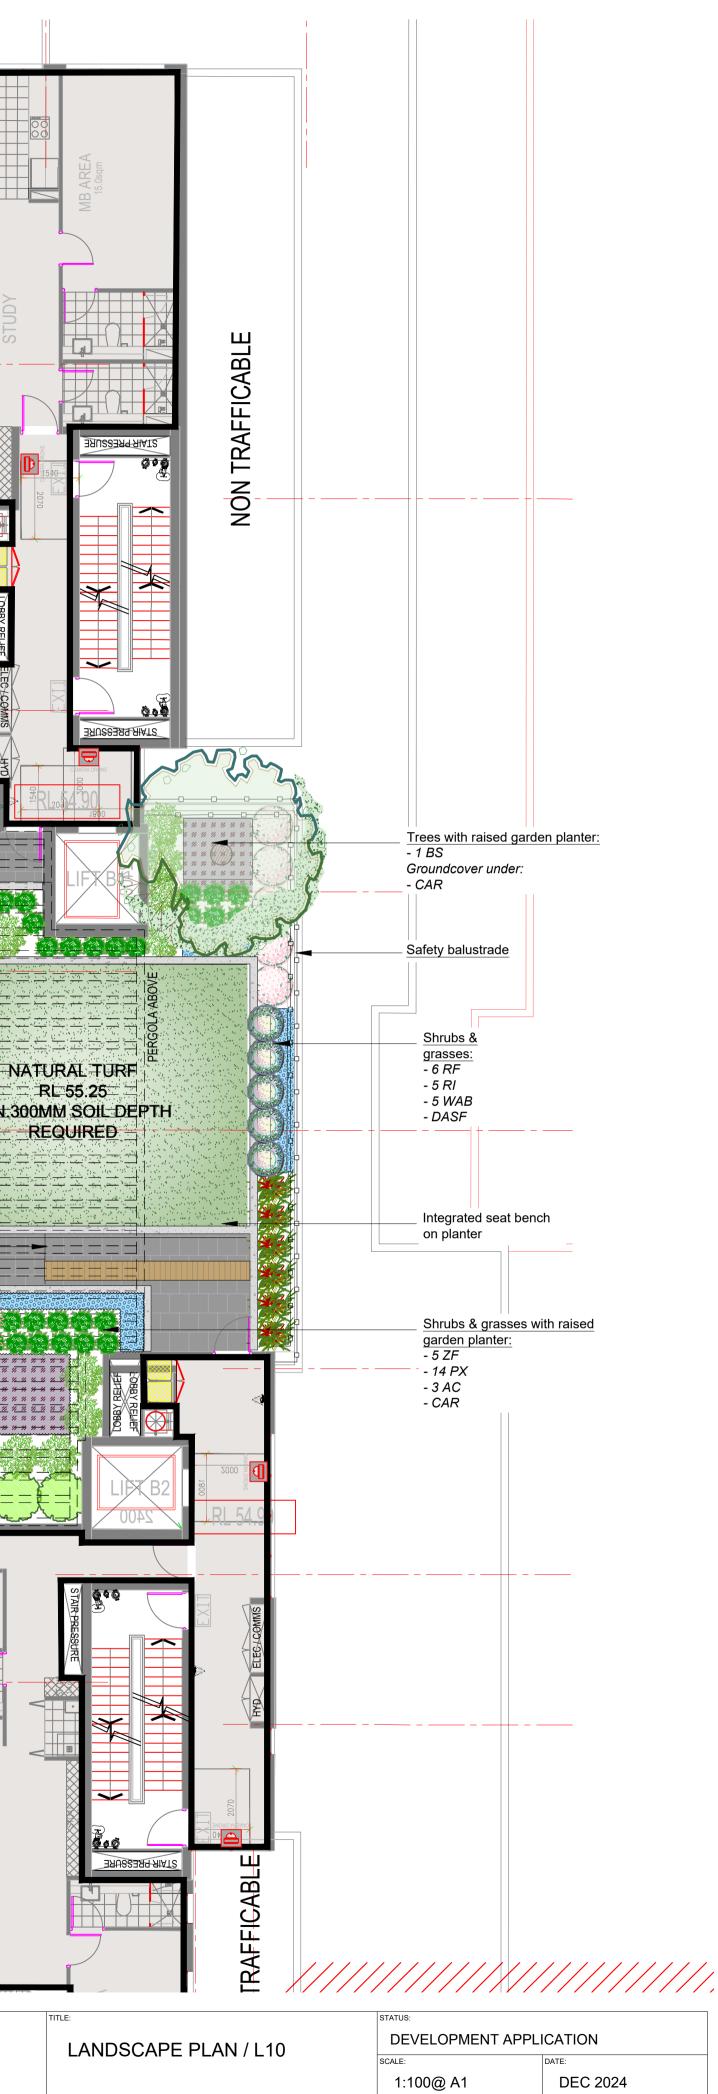

		1:100@ A1	DEC 2024
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LPDA 25- 75	LP05	L.Z/E.W	R.F



ARCHITECT



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- Me


Australian Institute of Fandscape Architects


AILA Associate


discrepancies to the Landscape Architect before proceeding with the work. Copyright Subplurerest Enterprises Pty Ltd Trading as CONZEPT (ABN: 75 623 405 630) This drawing is protected by copyright. All rights are reserved. Unless permitted under the Copyright Act 1986, no part of this drawing may in any form or by any means be reproduced, published, broadcast or transmitted without the prior written permission of the copyright owner. If the Status of this drawing is not signed off For Construction it may be subject to change, alteration or amendment at the discretion of our office.

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GENERAL NOTE:



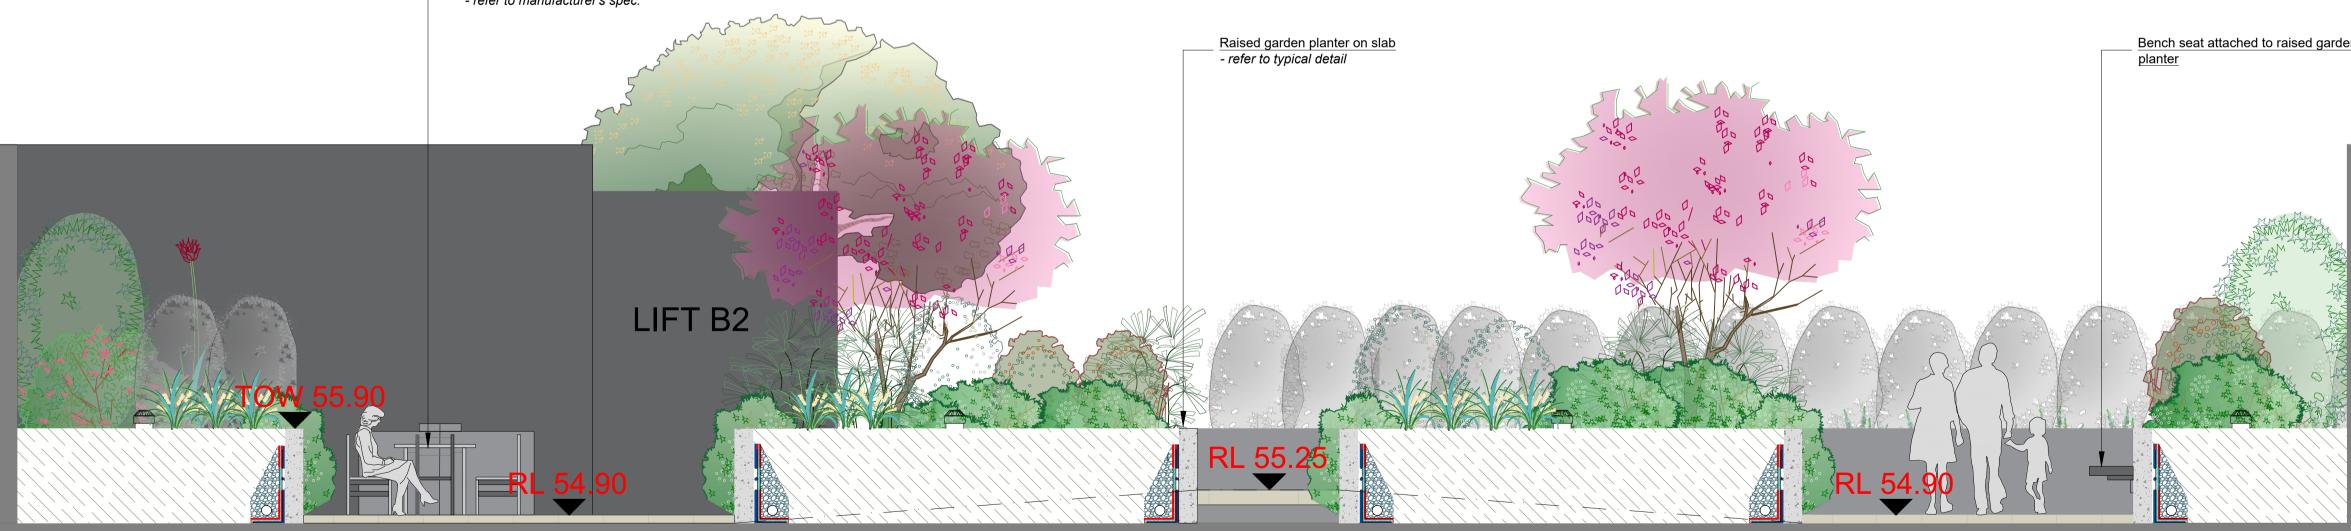

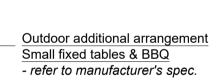


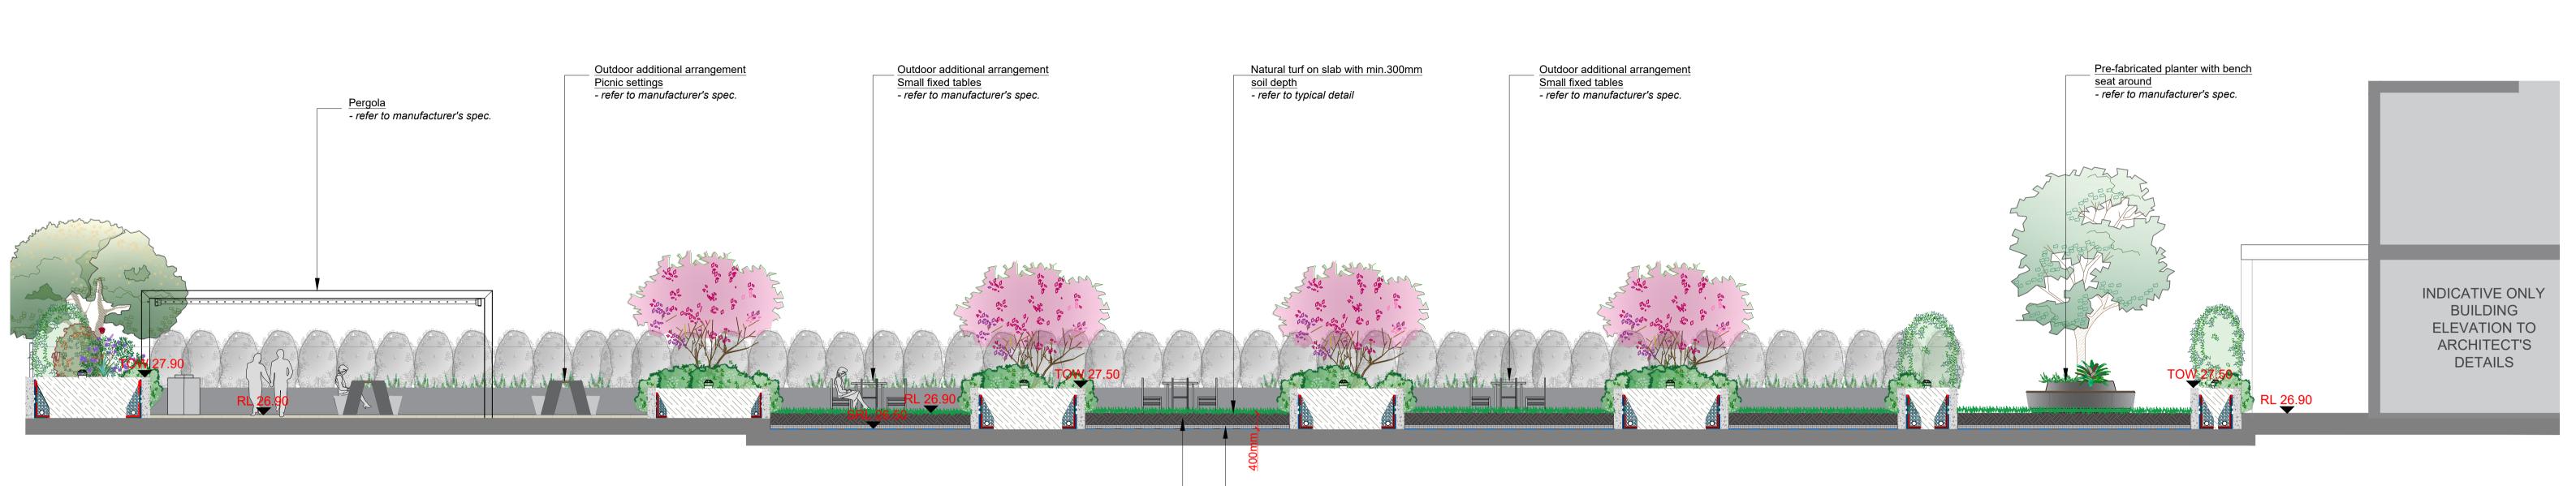100mm Waterproofing & drainage cell

– Min. 300mm soil depth required





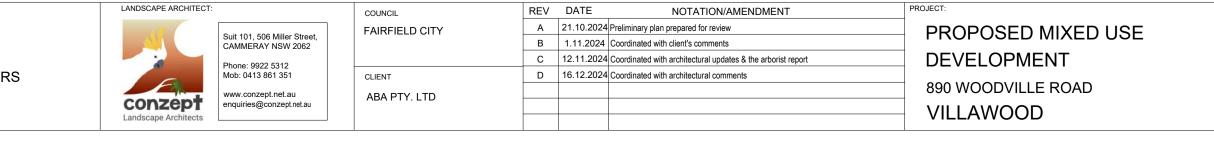

	TITLE:		STATUS: DEVELOPMENT APPLICATION	
SECTIONS				
	SECTIONS		SCALE:	DATE:
				DEC 2024
	DWG.No:	PAGE NUMBER:	DRAWN:	CHECKED:
	LPDA 25- 75	LP06	L.Z/E.W	R.F

INDICATIVE ONLY BUILDING **ELEVATION TO** ARCHITECT'S DETAILS

Bench seat attached to raised garden

LANDSCAPE WORK SPECIFICATION

PRELIMINARIES

1.01 GENERAL

The following general conditions should be considered prior to the commencement of landscape works The landscape plans should be read in conjunction with the architectural plans, project arborist's assessment

- hydraulic plans, service plans and survey prepared for the proposed development. All services including existing drainage should be accurately located prior to the commencement of landscape
- installation. Any proposed tree planting which falls close to services will be relocated on site under the instruction of the landscape architect. Installation of conduit for required irrigation, electrical and other services shall be completed prior to the
- commencement of hardscape works and hardstand pours.
- All outdoor lighting specified by architect or client to be installed by qualified electrician Anomalies that occur in these plans should be brought to our immediate attention.
- Where an Australian Standard applies for any landscape material testing or installation technique, that standard shall be followed.

1.02 PROTECTION OF ADJACENT FINISHES

The Contractor shall take all precautions to prevent damage to all or any adjacent finishes by providing adequate protection to these areas / surfaces prior to the commencement of the Works

1.03 PROTECTION OF EXISTING TREES

Existing trees identified to be retained shall be done in accordance with (AS)4970-Protection of trees on development sites as well as in accordance with the tree protection measures prepared by project arborist.

Where general works are occurring around such trees, or pruning is required, a qualified Arborist shall be engaged to oversee such works and manage tree health. Existing trees designated on the drawing for retention shall be protected at all times during the construction period. Any soil within the drip-line of existing trees shall be excavated and removed by hand only. No stockpiling shall occur within

the root zone of existing trees to be retained Any roots larger in diameter than 50mm shall only be severed under instruction by a gualified arborist. Roots smaller than

50mm diameter shall be cut cleanly with a saw. Temporary fencing shall be installed around the base of all trees to be retained prior to the commencement of landscape

works. Where possible this fencing will be located around the drip line of these trees, or a minimum of 3m from the trunk. The fencing shall be maintained for the full construction period.

1.04 EROSION & POLLUTION CONTROL

The Contractor shall take all proper precautions to prevent the erosion of soil from the subject site. The contractor shall install erosion & sediment control barriers and as required by council, and maintain these barriers throughout the construction period. Note that the sediment control measures adopted should reflect the soil type and erosion characteristics of the site.

Erosion & pollution control measures shall incorporate the following:

- Construction of a sediment trap at the vehicle access point to the subject site - Sediment fencing using a geotextile filter fabric in the location indicated on the erosion control plan or as instructed on

site by the landscape architec

- Earth banks to prevent scour of stockpiles - Sandbag kerb sediment traps

- Straw bale & geotextile sediment filter.

- Exposed banks shall be pegged with an approved Jute matting in preparation for mass planting

Refer to "Sitewise Reference Kit" as prepared by DLWC & WSROC (1997) for construction techniques

SOIL WORKS

2.01 MATERIALS

Specified Soil Conditioner (Generally to improve site soil)

The specified soil conditioner for site top-soil improvement shall be an organic mix, equal to "Botany Humus", as supplied by ANL. Note that for sites where soil testing indicates toxins or extremes in pH, or soils that are extremely poor, allow to excavate and supply 300mm of imported soil mix.

New gardens & proposed Planting

New garden and planting areas shall consist of a 50/50 mix of clean site soil (refer d) below) and imported "Organic Garden Mix" as supplied by ANL or approved equal. All mixes are to comply with AS 4419 Soils for landscaping & garden use, & AS 4454 Composts, Soil conditioners & mulches.

Specified Soil Mix - Turf

The specified soil mix for all turf areas shall be a min 75mm layer of imported soil mix consisting of 80% washed river sand (reasonably coarse), and 20% composted organic matter equivalent to mushroom compost or soil conditioner, or other approved lawn top dress.

Site Topsoil

Site topsoil is to be clean and free of unwanted matter such as gravel, clay lumps, grass, weeds, tree roots, sticks, rubbish and plastics, and any deleterious materials and materials toxic to plants. The topsoil must have a pH of between 5.5 and 7. Use 100% imported soil mix when site when site topsoil runs out.

2.02 INSTALLATION (TO GARDEN OUTSIDE OF TREE PROTECTION ZONES OF TREES RECOMMENDED TO BY RETAINED)

Note: No level changes (Cut or Fill), soil ripping within the Tree Protection Zones of trees to be retained a) Testing All testing is to be conducted in accordance with AS 1289 Methods for testing soils for engineering purposes. Site soil

shall be given a pH test prior to modifying to ensure conditions are appropriate for planting as stated above. Tests shall be taken in several areas where planting is proposed, and the pH shall be adjusted accordingly with sulphur or lime to

Note that a soil test conducted by the "Sydney Soil Lab" or approved equal shall be prepared for all commercial. industrial and multi-unit residential sites. The successful landscape contractor shall implement the recommendations of this test.

b) Set Out of Individual Trees & Mass Planting Areas

All individual tree planting positions and areas designated for mass planting shall be set out with stakes or another form of marking, ready for inspection and approval. Locate all services.

c) Establishing Subgrade Levels outside of tree protection zones of trees to be retained Subgrade levels are defined as the finished base levels prior to the placement of the specified material (i.e. soil

conditioner). The following subgrade levels shall apply: Mass Planting Beds - 300mm below existing levels with specified imported soil mix.

Turf areas - 100mm below finished surface level. Note that all subgrades shall consist of a relatively free draining natural material, consisting of site topsoil placed previously by the Civil Contractor. No builders waste material shall be acceptable.

d) Subgrade Cultivation

Cultivate all subgrades to a minimum depth of 100mm in all planting beds and all turf areas, ensuring a thorough breakup of the subgrade into a reasonably coarse tilth. Grade subgrades to provide falls to surface and subsurface drains, prior to the placement of the final specified soil mix.

e) Drainage Works

Install surface and subsurface drainage where required and as detailed on the drawing. Drain subsurface drains to outlets provided, with a minimum fall of 1:100 to outlets and / or service pits.

f) Placement and Preparation of Specified Soil Conditioner & Mixes.

Trees in turf & beds - Holes shall be twice as wide as root ball and minimum 100mm deeper - backfill hole with 50/50 mix of clean site soil and imported "Organic Garden Mix" as supplied by ANL or approved equal. Mass Planting Beds - Install specified soil conditioner to a compacted depth of 100mm

Place the specified soil conditioner to the required compacted depth and use a rotary hoe to thoroughly mix the conditioner into the top 300mm of garden bed soil. Ensure thorough mixing and the preparation of a reasonably fine tilth

and good growing medium in preparation for planting. Turf Areas - Install specified soil mix to a minimum compacted depth of 75mm. Place the specified soil mix to the required compacted depth and grade to required finished soil levels, in preparation for

planting and turfing.

PLANTING 3.01 MATERIALS

a) Quality and Size of Plant Materia All trees supplied above a 25L container size must be grown and planted in accordance with AS 2303:2018 'TREE STOCK FOR LANDSCAPE USE' Certification that trees have been grown to AS 2303:2018 is to be provided upon

request of Council's Tree Management Officer. Above - Ground Assessment:

The following plant quality assessment criteria should be followed Plant true to type, Good vigour and health, free from pest & disease, free from injury, self-supporting, good stem taper,

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has been pruned correctly, is apically dominant, has even crown symmetry, free from included bark & stem junctions. even trunk position in pot, good stem structure

Below - Ground Assessment:

Good root division & direction, rootball occupancy, rootball depth, height of crown, non-suckering For further explanation and description of these assessment criteria, refer to Ross Clark's book. All Plant material shall be to the type and size specified. No substitutions of plant material shall be permitted without written prior approval by the Landscape Architect. No plant shall be accepted which does not conform to the standards

b) Stakes and Ties

listed above.

GENERAL NOTE

Provide min 3 No. Stakes and ties to all plants identified as trees in the plant schedule. Stakes shall be sound, unpainted, straight hardwood, free of knots and pointed at one end. They shall be 1800mm x 50mm x 50mm Hardwood timber, or as per council specification where is available. Ties shall be 50mm wide hessian webbing material.

withdraw this information from the assessment process if suc

AILA Associate

Fertilisers shall be approved slow release fertilisers suitable for the proposed planting types. Note that for native plants, specifically Proteaceae family plants including Grevillea species, low phosphorus fertilizers shall be used. d) Mulch

Mulch for general planter bed shall be an approved equal to "eucy" as supplied by ANL. Mulch shall be completely free from any soil, weeds, rubbish or other debris. Mulch for bio-retention/rain garden area where is required shall be non-floatable materials that could include crushed rock, gravel, coarse river sand, scoria or river pebbles. 4-7mm screenings or similar.

Turf for project site shall be soft leaf Buffalo or Zoysia macrantha 'Nana' or equivalent unless stated otherwise), free from any weeds and other grasses, and be in a healthy growing condition. Re-turfing to nature strip where is required shall use species that match existing on street

3.02 INSTALLATION a) Setting Out

All planting set out shall be in strict accordance with the drawings, or as directed. Note that proposed tree planting located near services should be adjusted at this stage. Notify Landscape Architect for inspection for approval prior to planting.

b) Planting

All plant material shall be planted as soon after delivery as possible. Planting holes for trees shall be excavated as detailed and specified. Plant containers shall be removed and discarded, and the outer roots gently teased from the soil mass. Immediately set plant in hole and backfill with specified soil mix, incorporating the approved quantity of fertiliser for each plant type. Ensure that plants are set plumb vertically and root balls set to the consolidated finished grades detailed on the drawings. Compact the backfilled soil and saturate by hand watering to expel any remaining air pockets immediately after planting.

c) Staking and Tying

d) Mulching Mulch for general planter bed shall be an approved equal to "eucy" as supplied by ANL. Mulch shall be completely free from any soil, weeds, rubbish or other debris. Mulch for bio-retention/rain garden area where is required shall be non-floatable materials that could include crushed rock, gravel, scoria or river pebbles. 4-7mm screenings or similar.

Staking and tying shall be in strict accordance with the drawings and shall occur immediately following plant placement

and soil backfilling. All plants identified as "Trees" on the planting schedule shall be staked with a min. 3 stakes.

Moisten soil prior to the turf being laid. Turf shall be neatly butt jointed and true to grade to finish flush with adjacent

e) Turfing

surfaces. Incorporate a lawn fertilizer and thoroughly water in. Keep turf moist until roots have taken and sods/rolls cannot be lifted. Keep all traffic off turf until this has occurred. Allow for top dressing of all turf areas. All turf shall be rolled immediately following installatior

f) Earth retaining structure

All walls which form part of drainage works must be built as detailed by the hydraulic engineer. All walls exceeding 800mm shall be of not timber construction materials, construction details to be provided by a qualified engineer. Install wall to suit site levels and to manufacture's specification.

HARDSCAPE WORKS

4.01 GENERAL

The Contractor shall undertake the installation of all hardscape works as detailed on the drawing, or where not detailed

by manufacturers specification. Paving - refer to typical details provided, and applicable Australian Standards. Permeable paving may be used as a suitable means of satisfying Council permeable surface requirements, while providing a useable, hardwearing, practical surface. In most instances, the client shall nominate the appropriate paving material to

be used. Australian Standards shall be adhered to in relation to all concrete, masonry & metal work. Some details are typical and may vary on site. All hardscape works shall be setout as per the drawings, and inspected and approved by the Landscape Architect prior to installation. All workmanship shall be of the highest standard. Any queries or problems that arise from hardscape variations should be bought to the attention of the Landscape Architect. Your attention is directed to any obligations or responsibilities under the Dividing Fences Act, 1991 in respect of adjoining property owner/s which may arise from this application. Any enquiries in this regard may be made to the Crown Lands Division on (02) 8836 5332

IRRIGATION WORKS

5.01 GENERAL (PERFORMANCE SPECIFICATION)

New irrigation systems to planting areas shall be a Commercial Grade Irrigation System conforming to all relevant Australian standards, including AS 3500 & the Electrical Safety Act 2002, Workplace Health & Safety Act 2011, & the latest Sydney Water Code

An automated drip-irrigation system is to be installed to all gardens, planters and lawn areas in accordance with the approved Irrigation Design.

This system shall be designed and installed by a qualified and licensed irrigation specialist, to industry standards and to maximise the efficient usage of water.

Drawings: - The Landscape Contractor nominated Licensed Irrigation Specialist shall provide irrigation drawings for approval upon engagement.

Design Requirements:

- The irrigation system shall be installed prior to all planting works. It shall incorporate a commercially available irrigation system, with sub-surface dripper lines to irrigate all gardens, planters and lawn areas. - It shall incorporate a suitable back flow prevention device for the scale of works an in-line filter, check valves and suitable high and low density poly hose fittings and PVC piping to achieve flow rates suitable for specified planting.

- The irrigation application rate shall not exceed the infiltration rate of the soil or creates run-off. The landscape contractor shall check the existing pressure available from the ring mains and size irrigation piping to suit. Supply shall be from local hose cock where available.

- All piping and fittings shall be buried 50mm below the finished soil levels in garden and lawn areas, and secured in position at 500mm centres with galv wire pins. - Size of pipes shall be selected to ensure the working pressure at the end of the line does not decrease by more than

Services Co-ordination:

- Co-ordination required by Landscape Contractor or Project Manager to provide required conduit, pipe work and penetration through slabs and planter walls for water and power provisions. - The Landscape Contractor shall be engaged with the Irrigation Specialist to co-ordinate with the Project Manager to identify the preferred service and conduit locations. - Project Manager and Landscape Contractor to establish area suitable for irrigation control system with required area,

immediately rectified.

Further Documentation:

CONSOLIDATION AND MAINTENANCE

The consolidation and maintenance period shall be either :

or as specified by Council in the Determination.

any defects that become apparent in the contracted works.

Clearing litter and other debris from landscaped areas.

• Replacement of damaged, stolen or unhealthy plants.

• Make good areas of soil subsidence or erosion.

Spray / treatment for Insect and disease control

· Fertilizing with approved fertilizers at correct rates

• Topping up of mulched areas.

Adjusting ties to Stakes

Removing weeds, pruning and general plant maintenance

• Watering all planting and lawn areas / irrigation maintenance.

Maintenance of all paving, retaining and hardscape elements.

Warranty :

6.01 GENERAL

power provision and water supply.

Testing & Defects Upon completion of installation, the system shall be tested, including:

- A full 12 month warranty shall be included to cover labour and all parts.

- On request, a detailed irrigation performance specification report can be issued.

as agreed to in the landscape contractors contractual obligations.

This shall include, but not be limited to, the following items where and as required:

• Mowing lawns & trimming edges each 14 days in summer or 18 days in winter

superintendent or landscape architect, the responsibility will be signed over to the client.

- Main Line Pressure Test: The main line is pressurised to test for leaks. All valves are shut and the pressure is taken over a determined length of time - Dripper Pressure Test: Measurement at flushing valves are taken and the pressure gauged to make sure it conforms to

the manufacturer recommendations. The inlet pressure is then tested under the same conditions to check it does not exceed 300Kpa. - All components are to be satisfactorily functional and operational prior to approval. Should any defect develop, or the

6 months beginning from the approved completion of the specified construction work (Practical Completion)


A qualified landscape maintenance contractor shall undertake the required landscape maintenance works. Consolidation

and maintenance shall mean the care and maintenance of Contracted works by accepted landscaping or horticultural

practices, ensuring that all plants are in optimum growing conditions and appearance at all times, as well as rectifying

On the completion of the maintenance period, the landscape works shall be inspected and at the satisfaction of the

capacity or efficiency of the system decline during the agreed maintenance system, then these faults shall be

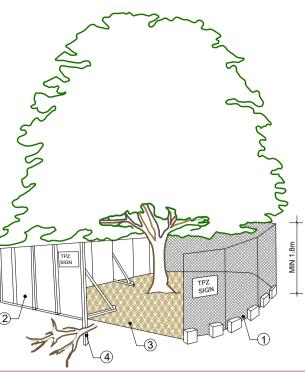

1. CHAIN WIRE MESH PANELS WITH SHADE CLOTH (IF REQUIRED) ATTACHED, HELD IN PLACE WITH CONCRETE FEET


2. ALTERNATIVE PLYWOOD OR WOODEN PALING FENCE PANELS. THE FENCING MATERIAL ALSO PREVENTS BUILDING MATERIALS OR SOIL ENTERING THE TPZ

3. MULCH INSTALLATION ACROSS SURFACE OF TPZ (AT THE DISCRETION OF THE PROJECT ARBORIST). NO EXCAVATION, CONSTRUCTION ACTIVITY, GRADE CHANGES, SURFACE TREATMENT OR STORAGE OF

MATERIALS OF ANY KIND IS PERMITTED WITHIN THE TPZ 4. BRACING IS PERMISSIBLE WITHIN THE TPZ. INSTALLATION OF SUPPORTS TO AVOID DAMAGING ROOTS

PROVIDE FENCING AS DETAILED TO ALL TREES PROPOSED TO BE RETAINED ON THE SUBJECT SITE. FENCING TO BE LOCATED TO THE DRIP LINE OF TREES OR AS INDICATED ON PLANS OR DIRECTED ON-SITE BY ARBORIST. NO STOCKPILING WITHIN FENCE PERIMETERS.



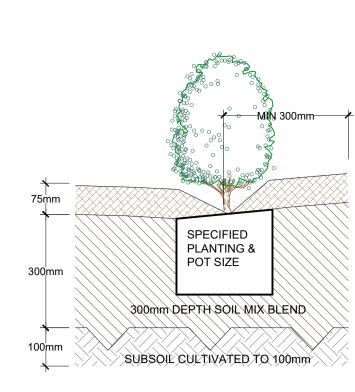

ARTIFICIAL TURF

SCALE: NTS

TYPICAL SETBACK FROM LAWN/GARDEN EDGE

75mm DEPTH "EUCY" MULCH OR EQUIVALENT


SOIL MIX:

50% OF STOCKPILED SITE TOPSOIL FREE FROM ALL BUILDER'S RUBBISH AND DELETERIOUS MATERIALS. TOPSOIL TO BE AMELIORATED, MIXED WITH MINIMUM 50% IMPORTED GARDEN MIX OR SOIL CONDITIONER/ COMPOSTED ORGANIC MATTER - SEE SPEC

USE 100% IMPORTED SOIL MIX WHEN SITE TOPSOIL RUNS OUT

TYPICAL GARDEN PREPARATION DETAIL SCALE 1:10

(ONLY APPLICABLE FOR PLANTING AREA OUTSIDE TREE PROTECTION ZONE OF TREES TO BE RETAINED. NO CHANGES ARE TO OCCUR TO EXISTING LEVELS, INCLUDING RIPPING/CULTIVATING OF THE SOIL WITHIN THE TPZ OF TREES TO BE RETAINED ON SITE)

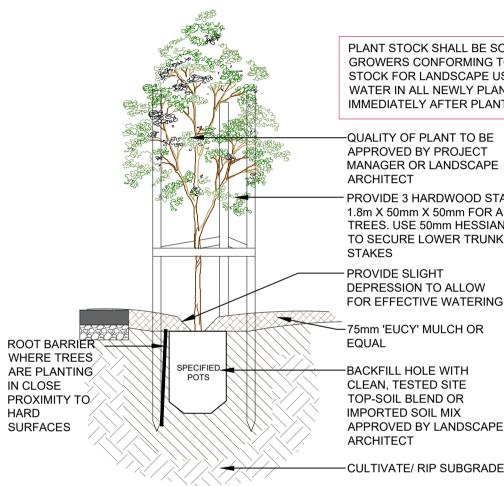

PLANT STOCK SHALL BE SOURCED FROM GROWERS CONFORMING TO AS 2303:2018 'TREE STOCK FOR LANDSCAPE USE' THOROUGHLY WATER IN ALL NEWLY PLANTED STOCK IMMEDIATELY AFTER PLANTING.

-QUALITY OF PLANT TO BE APPROVED BY PROJECT MANAGER OR LANDSCAPE ARCHITECT

- PROVIDE 3 HARDWOOD STAKES 1.8m X 50mm X 50mm FOR ALL TREES. USE 50mm HESSIAN TIES TO SECURE LOWER TRUNK TO STAKES - PROVIDE SLIGHT DEPRESSION TO ALLOW

FOR EFFECTIVE WATERING 75mm 'EUCY' MULCH OR

-BACKFILL HOLE WITH CLEAN, TESTED SITE TOP-SOIL BLEND OR IMPORTED SOIL MIX APPROVED BY LANDSCAPE ARCHITECT

30mm PILE HEIGHT WITH 20mm SAND INFILL TO MANUFACTURER'S SPECIFICATION ARTIFICIAL TURF UNDERLAY/SHOCK PAD 70mm THICKNESS TO ACCOMMODATE FALLS FROM MAXIMUM 1.6m FHOF(OR HEIGHT NOMINATED BY OPERATOR). PROPRIETARY PRODUCT TO MANUFACTURER'S SPECIFICATION. APPLY INDUSTRIAL APPROVED BONDING AGENT/ADHESIVE FOR PRODUCT FIXING — 250mm — ODMM DEPTH COMPACTED CRUSHER DUST SUBBASE TO 98% mbd SLOPE TO DRAIN-COMPACTED SUBGRADE STRIP GRASS MAT BASE FROM LEADING

*ALL ARTIFICIAL GRASS INSTALLED BY MANUFACTURE'S SPEC & DETAIL

TYPICAL RUBBERISED SOFTFALL AND

SYNTHETIC TURF IN NATURAL SOIL

SOFT RUBBER SURFACE 20-30mm DEPTH RUBBER WEARING LAYER OVER APPROVED SOFTFALL SPONGE LAYER. THICKEN TO ADJOINING FINISH

SOFTFALL SHOCKPAD LAYER 70mm THICKNESS TO ACCOMMODATE FALLS FROM MAXIMUM 1.6m FHOF(OR HEIGHT NOMINATED BY OPERATOR). PROPRIETARY PRODUCT TO MANUFACTURER'S SPECIFICATION.

METHOD.

EDGE TO 250mm, PEG DOWN WITH GALVANIZED PINS IN COMPACT BASE LAYER

TREE PLANTING DETAIL


SCALE: 1:10

IN CLOSE

HARD

(ONLY APPLICABLE FOR PLANTING AREA OUTSIDE TREE PROTECTION ZONE OF TREES TO BE RETAINED. NO CHANGES ARE TO OCCUR TO EXISTING LEVELS, INCLUDING RIPPING/CULTIVATING OF THE SOIL WITHIN THE TPZ OF TREES TO BE RETAINED ON SITE)



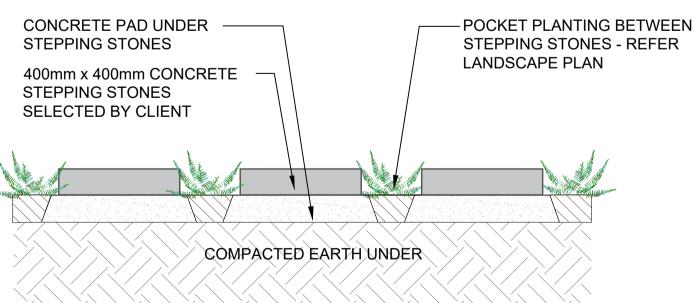

STEPPING STONES IN GROUNDCOVER PLANTING


SCALE 1:10

TONY OWEN PARTNERS

ALL FOOTINGS TO ENGINEERS -DETAILS AND SPECIFICATION

APPROX 1:10

	LANDSCAPE ARCHITECT:		COUNCIL	REV	DATE	NOTATION/AMENDMENT	PROJECT:
	and the second se	Quit 404 FOC Millor Street	FAIRFIELD CITY	А	21.10.2024	Preliminary plan prepared for review	PROPOSED MIXED USE
		Suit 101, 506 Miller Street, CAMMERAY NSW 2062		В	1.11.2024	Coordinated with client's comments	
		Phone: 9922 5312		С	12.11.2024	Coordinated with architectural updates & the arborist report	DEVELOPMENT
6		Mob: 0413 861 351	CLIENT	D	16.12.2024	Coordinated with architectural comments	
		www.conzept.net.au	ABA PTY. LTD				890 WOODVILLE ROAD
	conzept	enquiries@conzept.net.au					VILLAWOOD
	Landscape Architects						VILLAVVOOD

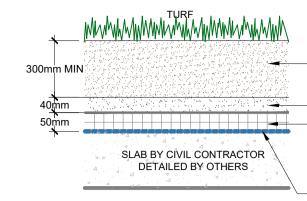


- TOPSOIL Refer Specification

- COARSE WASHED RIVER SAND - DRAINAGE CELL AND GEOTEXTILE FILTER CLOTH

WATERPROOF MEMBRANE To Architects Specification



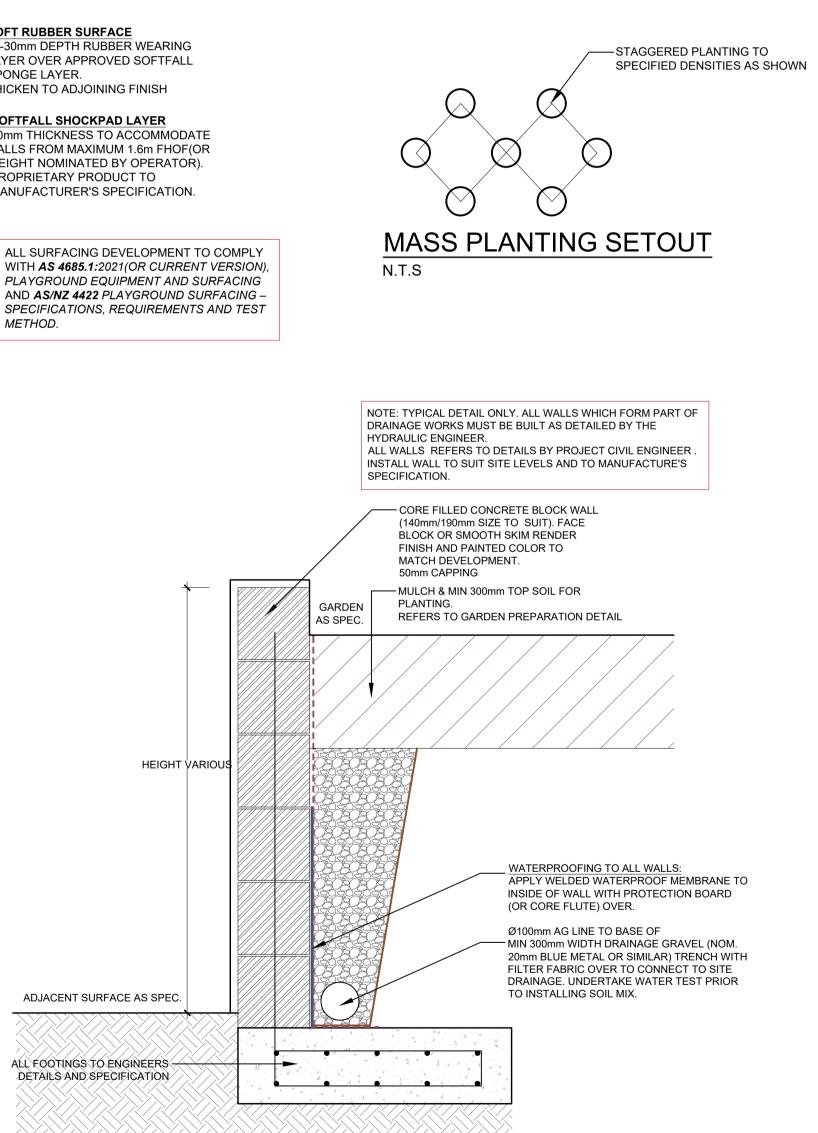

TYPICAL MASONRY BLOCK RETAINING WALL

TITLE:		STATUS:	STATUS:		
SPECIFICAT	ON & DETAILS	DEVELOPMENT	DEVELOPMENT APPLICATION		
		SCALE:	DATE:		
			DEC 2024		
DWG.No:	PAGE NUMBER:	DRAWN:	CHECKED:		
LPDA 25- 75	LP07	L.Z/E.W	R.F		

OVERFLOW (TO SUPPLIER'S SPECIFICATION)

NOTE (BCA COMPLIANCE).

WHERE NO EXTERNAL BALUSTRADE IS PROPOSED. THE INTERNAL PLANTER WALL FACE MUST BE NON-CLIMBABLE TO A HEIGHT TO MEET AS & BCA COMPLIANCE.


NOMINATED SURFACE FINISHES & WATER PROOFING (REFER TO SEPARATE DETAILS). FINISHED LEVEL TO ARCHITECT'S DETAILS

NOTE.(DRAINAGE & WATER PROOFING). DRAINAGE PITS AND LAYOUT TO BE

NOMINATED BY HYDRAULIC ENGINEER TO WORK WITH STRUCTURAL DESIGN AND LANDSCAPE.

THE WATERPROOFING, APPROVED DRAINAGE CELL AND SPECIFIED GEOFABRIC LAYER IN THIS DETAIL ARE INDICATIVE ONLY AND SHOULD BE DETAILED BY THE RELEVANT PROFESSIONAL ENGINEER 'FOR CONSTRUCTION'.

UNDER THE CONSTRUCTION PRACTITIONER BILL, STRUCTURAL WATER-PROOFING SHALL BE DOCUMENTED BY A HYDRAULIC ENGINEER

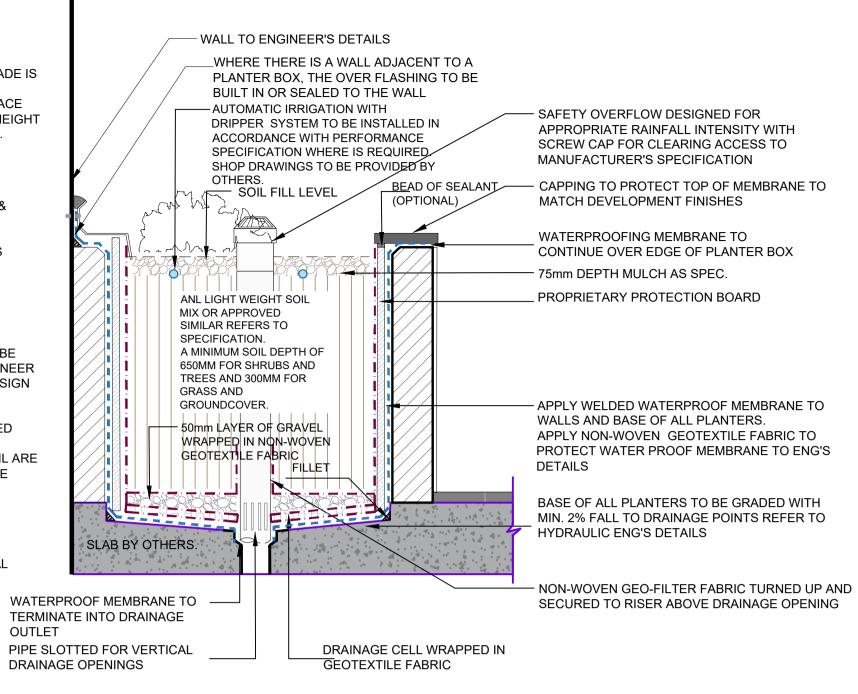

PLANTER WALL ON SLAB DETAIL

SCALE: nts PLANTER DETAIL TO CONFORM AS 4654.2-2012

Details

This Glassfibre Reinforced Concrete (GRC) collection provides dimension and scale to large, open spaces. It delivers on large and free-standing bench seating. Type A allows for the entire base to be filled with soil enabling tree roots to extend out further. Type B has a 1.1m square inner planter to hold the growing medium and is ideally suited to shrubs.

Our entire product range is made to order at our large and modern factory in Murwillumbah, NSW and we deliver Australia-wide.

All Quatro Design Quad seating units come with complimentary anti-graffiti sealant.


For customised concrete colour options visit our Colours, Options & Accessories page. Please note that we do not recommend painting seating units without timber tops or the use of dark mineral oxides, like charcoal, for outdoor seating. Dark surfaces can reach very high temperatures when placed in full sun.

Specifications

Length: 2400 mm Width: 2400 mm Height: 450 mm Rim: 400 Weight: 705 kg Code: QUAD-B

PRE-FABRICATED RAISED PLANTER BY QUATRO DESIGN/QUAD

SCALE NTS

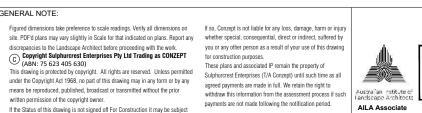



GENERAL NOTE:


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430-

NOTE: DRAWING IS INDICATIVE ONLY. PRODUCT BY COMMERCIAL SYSTEMS AUSTRALIA. REFER MANUFACTURER'S SPECIFICATIONS & INSTRUCTIONS FOR INSTALLATION

ODYSSEY PICNIC SETTING BY CSA - PRODUCT CODE: TM4170

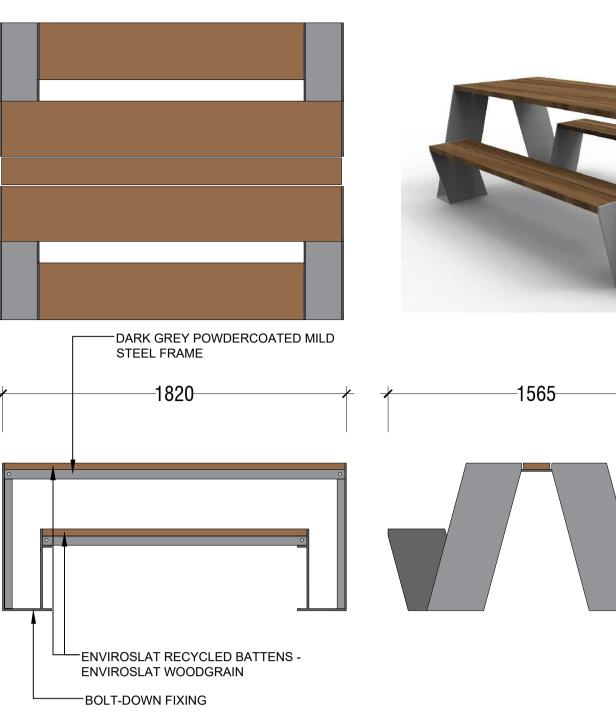SCALE 1:20

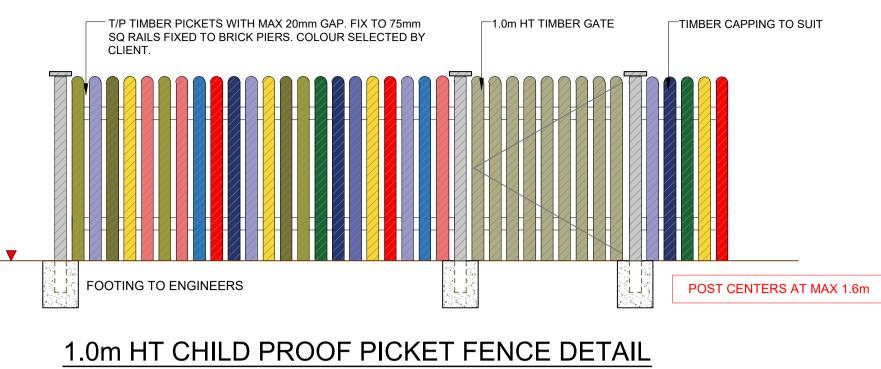Colours and Finishes

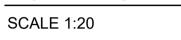White - made with pure white cement Kalgoorlie — made by adding coloured mineral

oxide during manufacture Concrete Grey — made with general purpose cement

Charcoal — made by adding coloured mineral oxide during manufacture

Other mineral oxide colours are available on special request refer to the <u>CCS Colour Card</u>

Options

- Skate deterrents
- Internal bitumen waterproofing membrane (non-toxic and fish-safe option also available)

Drainage

- Drainage Cell









Asplenium australasicum

	LANDSCAPE ARCHITECT:		COUNCIL	REV	DATE	NOTATION/AMENDMENT	PROJECT:
	100 M		FAIRFIELD CITY	Α	21.10.2024	Preliminary plan prepared for review	PROPOSED MIXED USE
		Suit 101, 506 Miller Street, CAMMERAY NSW 2062		В	1.11.2024	Coordinated with client's comments	
		Phone: 9922 5312		С	12.11.2024	Coordinated with architectural updates & the arborist report	DEVELOPMENT
TNERS		Mob: 0413 861 351	CLIENT	D	16.12.2024	Coordinated with architectural comments	
		www.conzept.net.au					890 WOODVILLE ROAD
	conzept	enquiries@conzept.net.au					VILLAWOOD
	Landscape Architects						VILLAWOOD
			-				·



Acer palmatum 'Ariadne'



Westringia 'Blue Gem'





Metrosideros 'Tahiti'



Acmena smithii 'Minor'



Lomandra longifollia 'Tanika'





Carpobrotus 'Aussie Rambler'





Syzygium 'Cascade'



SAMPLE IMAGES Images are for design intent only, final planting species may vary, as determined by

Council Approval

TIT	LE:		STATUS:			
	DETAILS 2		DEVELOPMENT APPLICATION			
BE 17 (120 2			SCALE:	DATE:		
				DEC 2024		
DWG.No: PAGE NUMB		PAGE NUMBER:	DRAWN:	CHECKED:		
	LPDA 25- 75	LP08	L.Z/E.W	R.F		



1. Playground equipment that measures 600mm or more above ground level requires a falling space and impact area.


2. Surfaces must have proof of testing in accordance with AS/NZS 4422

3. The maximum height of platforms in Education and Care Services is 1800mm 4. For static equipment items with platforms 600-1500mm above the ground, the falling space and impact area is 1500mm

5. A falling space/impact area of 1.7m is required for the maximum 1.8m platform height in SECS 6. Slides - Falling space and impact areas are required to be provided surrounding slides

elevated more than 600mm above the playing surface 7. Equipment less than 600mm above ground level must be provided with an impact area of less than 1500mm. Kidsafe NSW recommends a circulation zone of 1000mm is provided surrounding low equipment items that are designed for climbing rocking or jumping. 8. The maximum fall height for moveable equipment is 1.5m (at the highest foot support


and/or platform) 9. A minimum falling space and impact area of 1.5m is required for equipment items that measure 600mm or more above the ground.

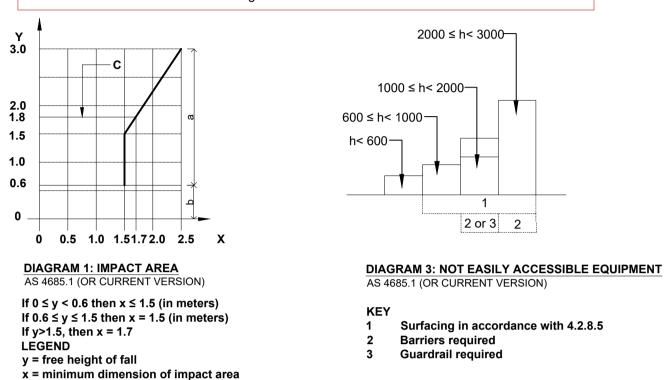


a = impact attenuating surface with requirements (4.2.8.5.2)

b = surface provided in accordance with 4.2.8.5.3 c = maximum free height of fall and impact area for

Supervised Early Childhood Services (SECS)

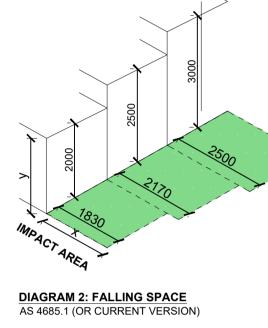

CHILDCARE / PLAYGROUND SAFETYFALL ZONES SCALE 1:20

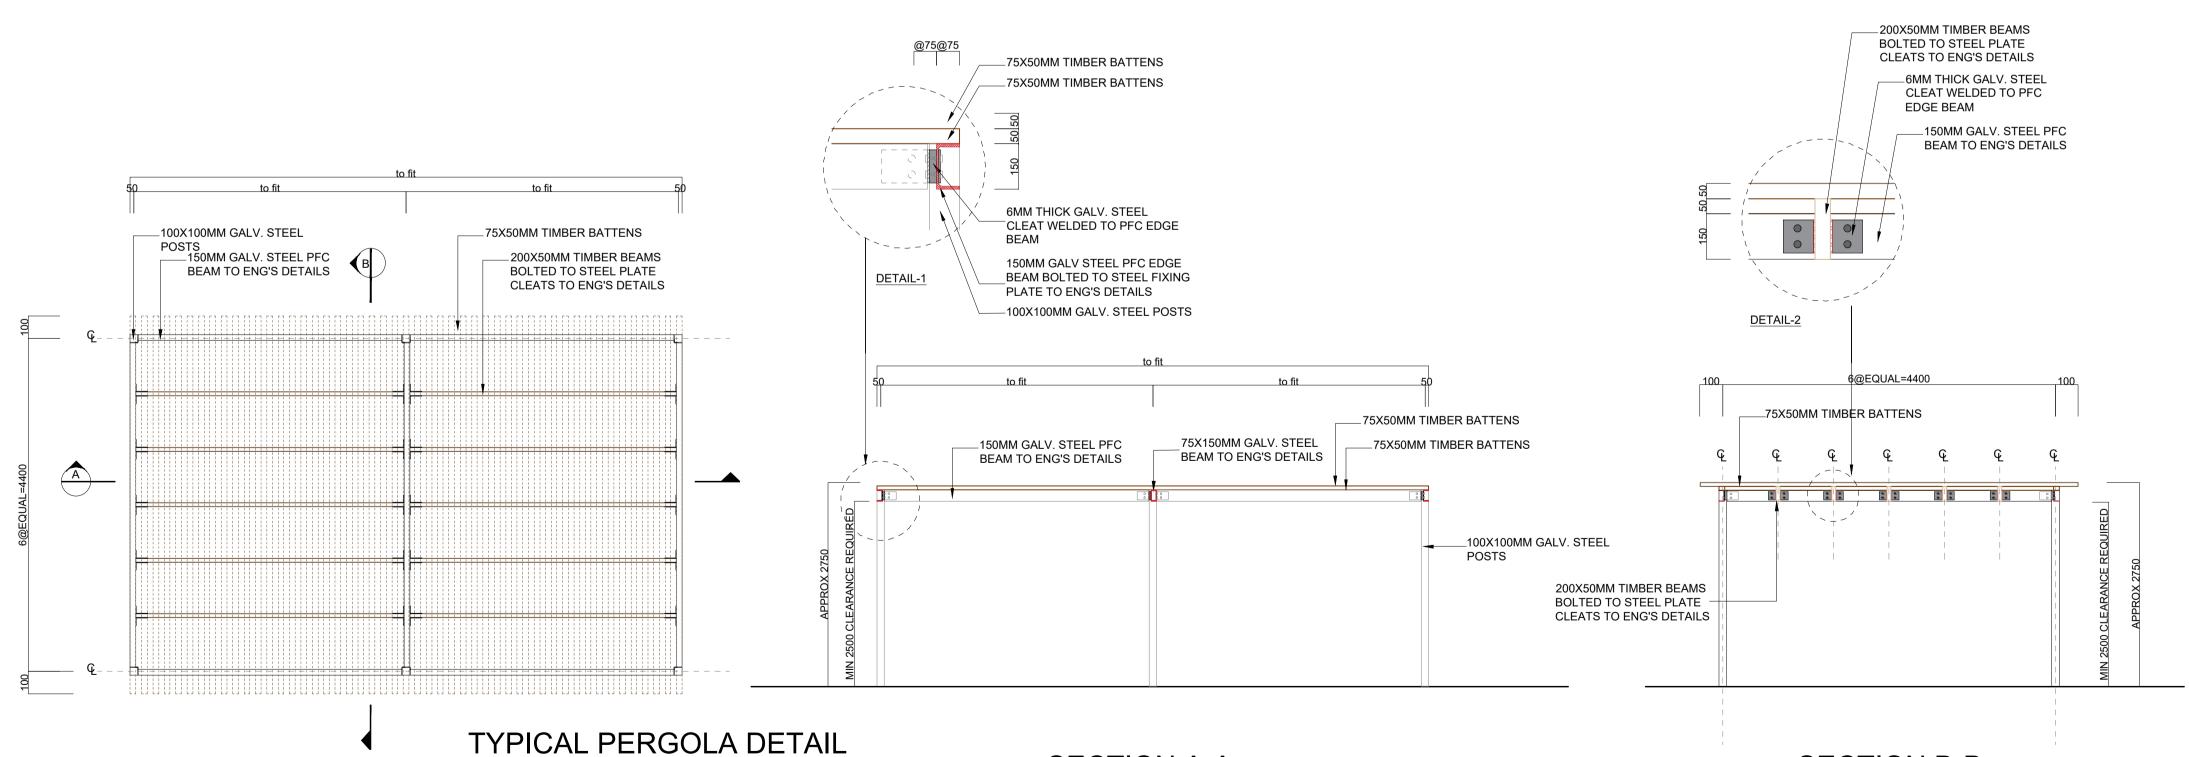

TYPICAL PERGOLA DETAIL

REFER TO MANUFACTURER'S DETAIL FOR FULL SPEC. SCALE 1:20

Figured dimensions take preference to scale readings. Verify all dimensions on site. PDFd plans may vary slightly in Scale for that indicated on plans. Report any whether special, consequential, direct or indirect, suffered by site: Pur's plans may vay signify in scale for that indicated on plans. Neport at discrepancies to the Landscape Architect before proceeding with the work. © Copyright Sulphurcrest Enterprises Pty Ltd Trading as CONZEPT ins drawing is protected by copyright. All rights are reserved. Unless permitted under the Copyright Act 1968, no part of this drawing may in any form or by any means be reproduced, published, broadcast or transmitted without the prior written permission of the copyright owner. If the Status of this drawing is not signed off For Construction it may be subject

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ARCHITEC



Material Specifications

Ironbark log posts Cypress decks & roof Spotted gum & Cypress activities Roto-moulded plastic slide Stainless steel fixings

Equipment Specifications

Max FHOF 800mm Fall zone area 47m2 Highest point 3619mm

Standards

AS4685 series

General Product Information

Age Group 3+ Colour options available Spare parts available Heaviest part Ironbark posts - machinery required

Issued 5/06/2023 LS V01

FOREST STRUCTURE BY PLAY WORKSHOP REFER TO MANUFACTURER'S SPEC.

SECTION A-A

LANDSCAPE ARCHITECT

SECTION B-B

PROJECT


	Suit 101, 506 Miller Street, CAMMERAY NSW 2062
	Phone: 9922 5312 Mob: 0413 861 351 www.conzept.net.au
CONZEPT Landscape Architects	enquiries@conzept.net.au

FAIRFIELD CITY

COUNCIL

REV DATE NOTATION/AMENDMENT A 21.10.2024 Preliminary plan prepared for review B 1.11.2024 Coordinated with client's comments C 12.11.2024 Coordinated with architectural updates & the arborist report D 16.12.2024 Coordinated with architectural comments

PROPOSED MIXED USE DEVELOPMENT 890 WOODVILLE ROAD VILLAWOOD

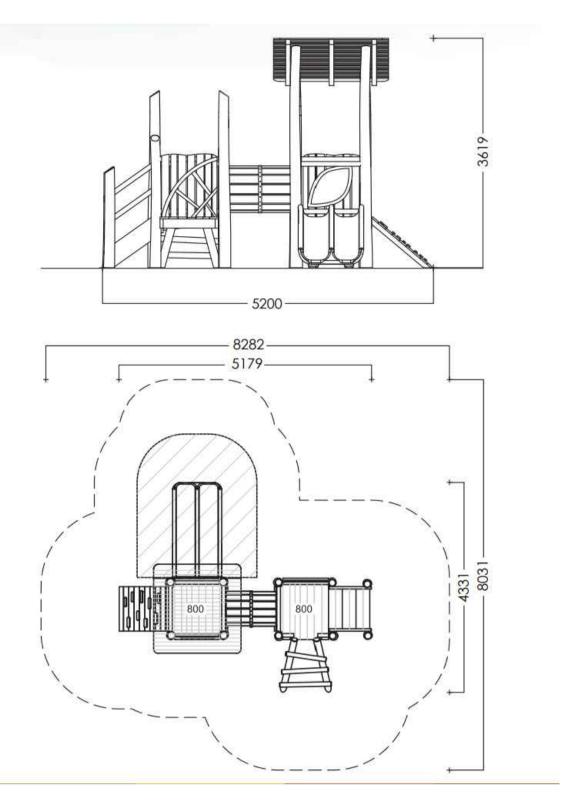

NOTE: DETAIL PROVIDED FOR DESIGN INTENT ONLY, TO BE REVIEWED AND VERIFIED WITH FURTHER DETAILING PROVIDED AS REQUIRED FOR CONSTRUCTION BY ARCHITECT/ STRUCTURAL ENGINEER



SAMPLE IMAGE

		STATUS: DEVELOPMENT APPLICATION		
		SCALE:	DATE:	
			DEC 2024	
DWG.No:	PAGE NUMBER:	DRAWN:	CHECKED:	
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